

McCarthy Park













SITE LEGEND:

- 1 Youth Soccer Field
- Existing Park Parking
- 3 Existing Baseball Field
- 4 Existing Softball Field
- 5 Existing Soccer Field
- 6 Gathering Space
- 7 Trail
- 8 Neighborhood Connections / Entry
- 9 Vegetative Buffer
- 10 Storage
- Demolish Existing Structures
- Pathway Lighting
- ••• Field Lighting
- Scoreboard
- Security Camera

McCarthy Park (North End)













SITE LEGEND:

- Existing Soccer Field
- 2 Existing Football Field
- 3 Existing Basketball Courts
- 4 Existing Baseball Field
- 5 Reconfigured Parking Lot
- 6 Children's Play
- 7 Shade Shelter / Pavilion
- 8 Restrooms & Storage
- 9 Concessions
- 10 Trail
- 11) Neighborhood Connections / Entry
- 12 Existing Tennis Courts
- 13) ADA Compliant Fitness Area
- Boulder Barrier
- Pathway Lighting
- ••• Field Lighting
- Scoreboard
- Security Camera

McCarthy Park (South End)











DRAWING LIST - McCARTHY PARK

General

G-001 General Notes, Legends & Drawing List

Landscape

L-000 Existing Conditions/ Survey
L-001 Existing Conditions/ Survey
L-002 Existing Conditions/ Survey
L-003 Existing Conditions/ Survey
L-004 Demolition Plan

L-004 Demolition Plan
L-101 Site Layout (North) Plan
L-102 Site Layout (South) Plan

C-101 Grading, Drainage & Utility (North) Plan C-102 Grading, Drainage & Utility (South) Plan

Architectural

A-101 Concession Building Renovations

Plumbing

PD-101 Plumbing First Floor Plan - Demolition P-101 Plumbing First Floor Plan


Mechanical

M-001 Cover Sheet
M-101 First Floor Mechanical

Electrical

E-101 Electrical Site Plan E-102 Electrical Site Plan

Drawing symbols

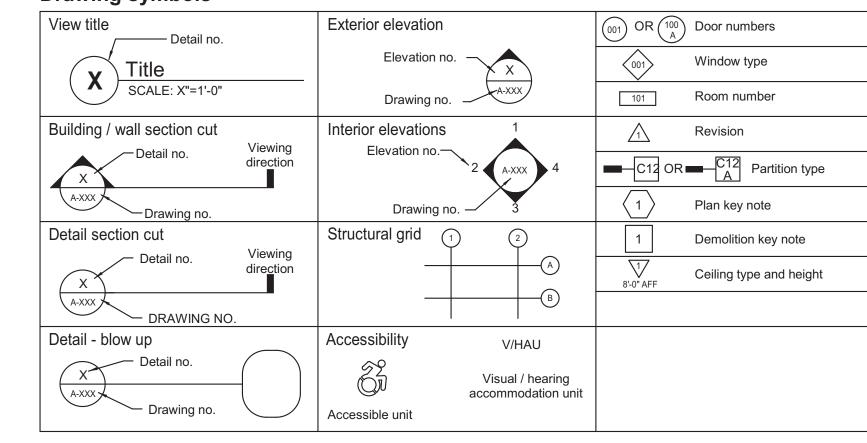


Material symbols

	Undisturbed earth		Steel - large scale (Other metals as noted)		Batt insulation
	Gravel or crushed stone	H	Steel - small scale (Other metals as noted)		Rigid insulation
	Stone	X	Wood framing (continuous)		Wood blocking (intermittent)
4	Concrete		Finish wood		
	Concrete masonry unit		Plywood		
	Brick		Gypsum, sand, mortar		
	· ·			-	· ·

Architectural / Structural abbreviations

3	Anchor bolt	DWV	Drainage waste & vent	LH	Left hand, Latent heat	RF	Resilient flooring
C CC	Air condition(ing) (ed) Accessible	DWG DWL	Drawing Dowel	LIN LKR	Linear Locker	RFG RH	Roofing Right hand. Roof hatch
CCU	Air cooled condensing unit	E	East	LL	Live load	RM	Room
CI	American Concrete Institute	EA	Each	LLH	Long leg horizontal	RO	Rough opening
CT CM	Acoustical ceiling tile Asbestos containing material	EBCNYS EC	Existing Building Code of New York State Electrical contractor	LLV	Long leg vertical Location	ROW RTU	Right of way Roof top unit
COUS PNL	Acoustical panel	EF	Each face	LRFD	Load & resistance factor design	RV	Roof vent
CS PNL	Access panel Additional	EIFS EJ	Exterior insulation and finish system	LT LTG	Light	RWB S	Rubber wall base South
DDL DJ	Adjustable, adjacent	ELAS	Expansion joint Elastomeric	LWC	Lighting Light-weight concrete	SAB	Sound attenuation batts
DH	Adhesive	EL	Elevation	MACH	Machine	SAN	Sanitary
FF GGR	Above finished floor Aggregate	ELEC ELEV	Electric(al) Elevator	MAINT MAS	Maintenance Masonry	SC SCHED	Solid core, Shading coefficier Schedule
HU	Air handling unit	EM	Entry mat, Expanded metal	MATL	Material	SEAL	Sealer on floor (finish)
SC SI	American Institute of Steel Construction American Iron and Steel Institute	EMER ENCL	Emergency Enclosure	MAX MC	Maximum Mechanical contractor	SECT SF	Section
оі _Т	Alternate	ENGR	Engineer	MCB	Metal corner bead	SFRM	Square foot, Safety factor Sprayed fire-resistive
LUM	Aluminum	EOS	Edge of slab	MDO	Medium density overlay		Material
NOD PPROX	Anodized Approximate	EP EQ	Electric panel Equal	MDF MECH	Medium density fiberboard Mechanical	SGT SHT	Structural glazed tile Sheet
RCH	Architect(ural)	EQUIP	Equipment	MEP	Mechanical, electrical, plumbing and fire protection	SHR	Shower
RD	Auxillary roof drain	ES ETC	Emergency shower	MEZZ MFR	Mezzanine Manufacturer	SIM SOG	Similar
SD STM	Allowable stress design American Society for Testing and Materials	ETR	Et cetera Existing to remain	MH	Manhole	SP	Slab on grade Standpipe, Sump pit
ΝP	Acoustical wall panel	EW	Each way	MM	Millimeter	SPA	Spaces
NS AT	American Welding Society Batten	EWC EXIST	Electric water cooler Existing	MIFRC MIN	Mastic/intumescent fire-resistive coating Minimum	SPKR SPEC	Speaker Specification
В	Back to back	EXC	Excavation, Excavate	MISC	Miscellaneous	SQ	Square
BD	Base board	EXP	Expand, Expansion	MLWK	Millwork	SRD	Secondary roof drain
CNYS TUM	Building Code of New York State Bituminous	EXT F/F	Exterior, External, Extinguisher Face to face	MO MRK BD	Masonry opening Marker board	SS SSM	Service sink Solid surface material
)	Board	FAAP	Fire alarm annunciator panel	MTD	Mounted	SSP	Stainless steel pipe
DG KG	Building	FACP FD	Fire alarm control panel	MTL	Metal Mullion	SST	Stainless steel
_KG И	Blocking Beam, Benchmark	FDTN	Floor drain Foundation	MULL N	Mullion North	STA	Stain Station
TC	Bottom	FE	Fire extinguisher	NAT	Natural	STC	Sound transmission class
₹ ₹G	Bedroom Bearing	FEC FHC	Fire extinguisher cabinet Fire hose cabinet	NCOMBL NIC	Noncombustible Not in contract	STD STIFF	Standard Stiffener
RZ	Bronze	FIN	Finish(ed)	NO OR #	Number	STL	Steel
SMT	Basement	FIXT	Fixture	NOM	Nominal	STOR	Storage
TWN JR	Between Built up roofing	FLASH FLEX	Flashing Flexible	NORM NRC	Normal Noise reduction coefficient	STR STRUCT	Straight, Stringers Structural
N	Both ways	FLOUR	Fluorescent	NTS	Not to scale	SUSP	Suspended
CTV	Closed circuit television	FLG	Flooring, flange	NWC O/O	Normal weight concrete Out to out	SV	Sheet vinyl
AB B	Cabinet Catch basin, Corner bead	FO FP	Finished opening Fire protection, Fireproof	O/O OA	Out to out Overall, Outside air	SY T	Square yard Tread
H BD	Chalkboard	FRTW	Fire retardant treated wood	oc	On center	T/	Top of
EM F	Cement Contractor furnished	FT FTG	Foot, Feet Footing	OD OF/CI	Outside diameter Owner furnished, Contactor installed	T&B T&G	Top and bottom Tongue and groove
r FMF	Cold-formed metal framing	FTR	Finned tube radiation	OF/OI	Owner furnished, Owner installed	TEL	Telephone
F/CI	Contractor furnished/ Contractor installed	FURN	Furnace, Furniture, Furnish	OFD	Overflow drain	THRES	Threshold
F/OI G	Contractor furnished/ Owner installed Corner guard	FUT FWC	Future Fabric wall covering	OFF OH	Office Opposite hand	TEMP TER	Temporary Terrazzo
H	Coat hook	GA	Gage	OH DR	Overhead (coiling) door	THK	Thick(ness)
	Cast iron	GAL	Gallon	OPNG	Opening	TK BD	Tack board
IP J	Cast in place, Cast iron pipe Control joint	GALV GB	Galvanized Grab bar	OPP OPT	Opposite Optional, Optimum	TMPD TOC	Tempered Top of concrete
L	Centerline	GC	General contract(or)	OZ	Ounce	TOM	Top of masonry
LG LO	Ceiling Closet	GFRC GFRG	Glass fiber reinforced concrete Glass fiber reinforced gypsum	PA PBD	Public address Particleboard	TOPO TOS	Topography, Topographic Top of steel
LR	Clear, Color	GL	Glass, Ground level	PC	Plumbing contractor, Portland cement	TOW	Top of wall
MT	Ceramic mosaic tile	GL BLK	Glass block	PCC	Precast concrete	TPD	Toilet paper dispenser
MU NTR	Concrete masonry unit Counter	GLU LAM GR	Glued laminated beam Grade. Gross	PCT PED	Porcelain ceramic tile Pedestal	TSTAT TV	Thermostat Television
0	Cleanout, Cased opening, Company	GWT	Glazed wall tile	PEND	Pendant	TYP	Typical
OL ONC	Column Concrete	GYP GYP BD	Gypsum board	PER PERF	Period Perforated	U UC	Heat transfer coefficient Undercut
ONF	Conference		Gypsum plaster	PGBD	Peg board	UCL	Under cabinet lighting
ONN	Connect(ion)	НВ	Hose bibb	PL	Plate, Property line	UGND	Underground
ONSTR ONT	Construction Continue(ous)	HC HCP	Hollow core, Hose cabinet Handicapped	PLF PLAM	Ponds per linear foot Plastic laminate	UH UL	Unit heater Underwriter's laboratories
ONTR	Contract(or)	HDW	Hardware	PLAS	Plaster	UNEX	Unexcavated
OORD	Coordinate	HDWD	Hardwood	PLB	Plumbing	UNFIN	Unfinished
PT SJ	Carpet Construction joint	HM HO	Hollow metal Hold open	PLYWD PNL	Plywood Panel	UON	Unless otherwise noted Utility
SK	Counter sunk	HORIZ	Horizontal	POL	Polished	UV	Unit ventilator
T TD	Ceramic tile, Count, Current transformer	HP HR	High point, Horsepower	PORC POS	Porcelain	VARN VB	Varnish(ed)
TR N	Center Cold water piping, Casement window	HR HSS	Hour Hollow structural section	POS	Positive, Position Pressure-preservative treated	VCT	Vinyl base Vinyl composition tile
J	Cubic	HT	Height	PR	Pair	VENT	Ventilation
JH J YD	Cabinet unit heater Cubic yard	HTG HTR	Heating Heater	PREFAB PREFIN	Prefabricate Prefinish	VERT VEST	Vertical Vestibule
JYD	Deep, Depth	HVAC	Heating, ventilating and air conditioning	PREP	Preparation	VEST	Verify in field
	Penny (nail)	HW	Hot water	PROJ	Project	VIN	Vinyl
) BL	Bar diameter Double	HYD ID	Hydrant Inside diameter	PROJ SCR	N Projection screen Pounds per square foot	VOL VR	Volume Vapor retarder
EFS	Direct-applied exterior finish system	IN	Inches	PSI	Pounds per square inch	VT	Vinyl tile
EG EMO	Degree Demolition	INCL	Included	PT PTN	Paint, Post tension	V SHT VWC	Vinyl sheet
EMO EPT	Demolition Department	INCAND INFO	Incandescent Information	PIN	Partition Polyvinyl chloride (plastic)	W WC	Vinyl wall covering West
EΤ	Detail	INSUL	Insulation	PVG	Paving	W/	With
= A OR ø	Drinking fountain Diameter	INTERM INT	Intermediate Interior	QT QTR	Quarry tile Quarter	WC W/O	Water closet, Wall covering Without
A OR Ø AG	Diagonal, Diagram	JAN	Janitor	QTY	Quantity	W/O WD	Wood
IM	Dimension	JST	Joist	R	Riser, Radius, Thermal resistance	WDW	Window
IFF IR	Diffuser Direction	JT KIP	Joint 1000 Pounds	RB RCP	Rubber base, Resilient base Reinforced concrete pipe, Reflected ceiling plan	WF WD GD	Wide flange Wood guard
IK ISP	Dispenser	KIT	Kitchen	RD	Reinforced concrete pipe, Reflected ceiling plan Roof drain, Road	WH	wood guard Water heater
IV	Division	ко	Knockout	REC	Recessed	WI	Wrought iron
MPF L	Damp proofing Dead load	KPL L	Kick plate Liter, Angle	REF REFL	Refrigerator Reflect	WM WP	Wire mesh Waterproofing, Working poin
N	Down	LAM	Laminate(d)	REG	Register, Regulation	WR	Water repellent, weather resi
0	Ditto	LAU	Laundry	REINF	Reinforced		Waste receptacle
R S	Door, Drive Downspout	LAV LB	Lavatory Pound	REQD RESIL	Required Resilient	WSCT	Wainscot Weight, Watertight, Water ta
N	Dishwasher	LBL	Label	REV	Revision	WWF	Welded wire fabric
		LD	Load			X	Ву
		l LF	Linear feet (foot)	1		YD	Yard

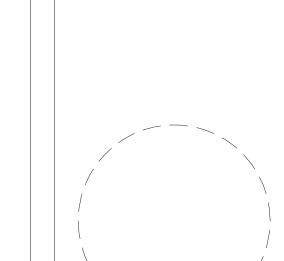

387 East Main Street Rochester NY 14604

585 232 8300 | rochester@swbr.com

Drawn By: JMB
Checked By: JMB
Project Manager: DP

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Revisions

City of Buffalo Parks & Buffalo Public School Facilities Survey & Design Development SWBR Project Number 18630.00

Community Foundation for Greater Buffalo 726 Exchange Street, Suite 525 Buffalo, NY 14210

G-001
McCarthy

General Notes, Legends & Drawing List

VICINITY MAP

NOTES:

MAPPING COMPILED BY PHOTOGRAMMETRIC METHODS FROM AERIAL PHOTOGRAPHY FLOWN DECEMBER 2018

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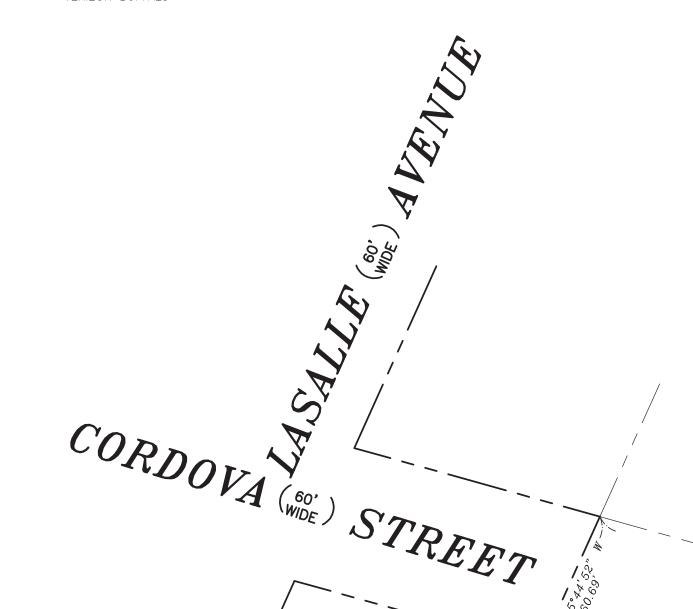
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THE FOLLOWING UTILITY COMPANIES WERE REQUESTED TO PROVIDE THE SURVEYOR THE LOCATION OF THEIR UNDERGROUND FACILITIES. THIN THE LIMITS OF THIS

UTILITY COMPANY / AGENCY	FACILITY	RESPONDED	AFFECTE
AT&T	FIBER, TELEPHONE	YES	NO
BUFFALO SEWER AUTHORITY	SEWER	YES	YES
CITY OF BUFFALO	TRAFFIC SIGNAL & PHONE	YES	YES
CITY OF BUFFALO WATER AUTHORITY	WATER	YES	YES
FIBERTECH NETWORKS NY	FIBER	NO	
LIGHTOWER FIBER TECHNOLOGIES	FIBER	YES	_
MCI	FIBER	NO	
NATIONAL FUEL GAS BUFFALO	GAS	NO	
NATIONAL FUEL GAS TONAWANDA	GAS	NO	
NATIONAL GRID/WEST/ELECTRIC	ELECTRIC	YES	YES
TIME WARNER CABLE - BUFFALO	FIBER AND CABLE	YES	YES
VERIZON BUFFALO	FIBER AND PHONE	YES	YES



GRAPHIC SCALE

(IN FEET) 1 inch = 40 ft.

	POOL	PILE
EDGE OF PAVEMENT	BUILDING UC	GOLF FAIRWAY
GUARDRAIL	FOUNDATION	UNDER CONSTRUCTION
TREELINE	RUINS	RUNWAY
FENCE GATE	MARSH OUTLINE	AIRFIELD PAVED
RIVER	POND, LAKE	AIRFIELD SHLDR
HEDGE	PAVED GUTTER	AIRFIELD PAINT
DIRTROAD	HEADWALL	
BUILDING (RES.)	DAM	HELICOPTER PAD
MISCLINE	PIPE END	ABANDONED RR
RETAINING WALL	CEMETERY	PAVED PARKING
CURB	<u>recreation</u> unpav	UNPAVED PARKING
INDEX OBS INDEX	TANK	AERIAL TC BOX
INTER OBS INTER	RECREATION PAVED	PIPE
INDEXD OBS INDEXD	TRAIL	AIR VENT
INTERD OBS INDTERE	BUILDING (MISC)	HEAT PUMP / AC
<u>SIDEWALK</u> DECK	CREEK	VALVE
STEPS	SOFTBREAK	LANDSCAPE
GRID (w/text)	HARDBREAK	END EXP JOINT
	<u>OBSCURED AREA</u>	ROAD CENTERLINE
RR	UNPAVED SHOULDER	UTILITY BOX
SIGN/OH SIGN	BUILDINGS (TEMP)	GREENS
ROAD PAINT	CANOPY	TRAPS_BUNKERS
PKG PAINT	FENCE GATE	TEES
TRAVELWAY	PHONE	INDEFINITE AREA
PAVED DRIVE	GUY	CULTIVATED FIELD
UNPAVED DRIVE	RAMP	<u>DOCK</u>
BRUSH	SMOKE	BRIDGE ROAD
CONTEXT ₁ 10 —	<u>OH PIPE</u>	BRIDGE CURB
BRIDGE	OH WALK	BRIDGE SIDEWALK
MAPPING LIMITS	CONVEYOR	MID EXP JOINT
SLAB, CONCRETE	LANDFILL	BRIDGE-BREAK_
WALL	OPEN STORAGE	OBSCURED BREAK
ROUND	SYMBOLS	
□ CB OCB		ل HANDI-CAP
□ SQUARE CB	-O- PWRPOLE	VALVE
♦ DI	♥ FIREHYD	• FLAG
DECIDUOUS BUSH	± SWAMP	UNOB
* CONIFEROUS BUSH	-J- PWRPOLEL	□ RAILSIG
× TC	TOWER (LINE)	Δ RAILSW
⊚ MH	CULV (LINE)	□ TRABOX
* • LAMPOST	† CEMETERY • AC or HEAT PU	* RUNLIGHT
DECIDUOUS TREE	→ POLES (MISC)	* TAXLIGHT
* CONIFEROUS TREE	X DTM SPOT	* TRASIG
1	× OBS DTM SPOT	• TREEBOLE
♭ SIGN	→ ANTENNA	™ MB VERT
POST	• SAT.DISH	VERT HOR
× SPOT	GUY (LINE)	<u> </u>
	OUT (LINE)	1 1 ¥

MATCHLINE SHEET L-001

S 00°45'56"





Checked By: Project Manager: M. POHL


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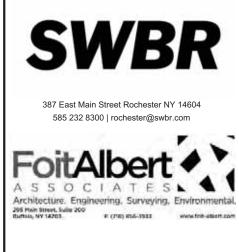
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L-000 **MCCARTHY**

Existing Conditions/Survey







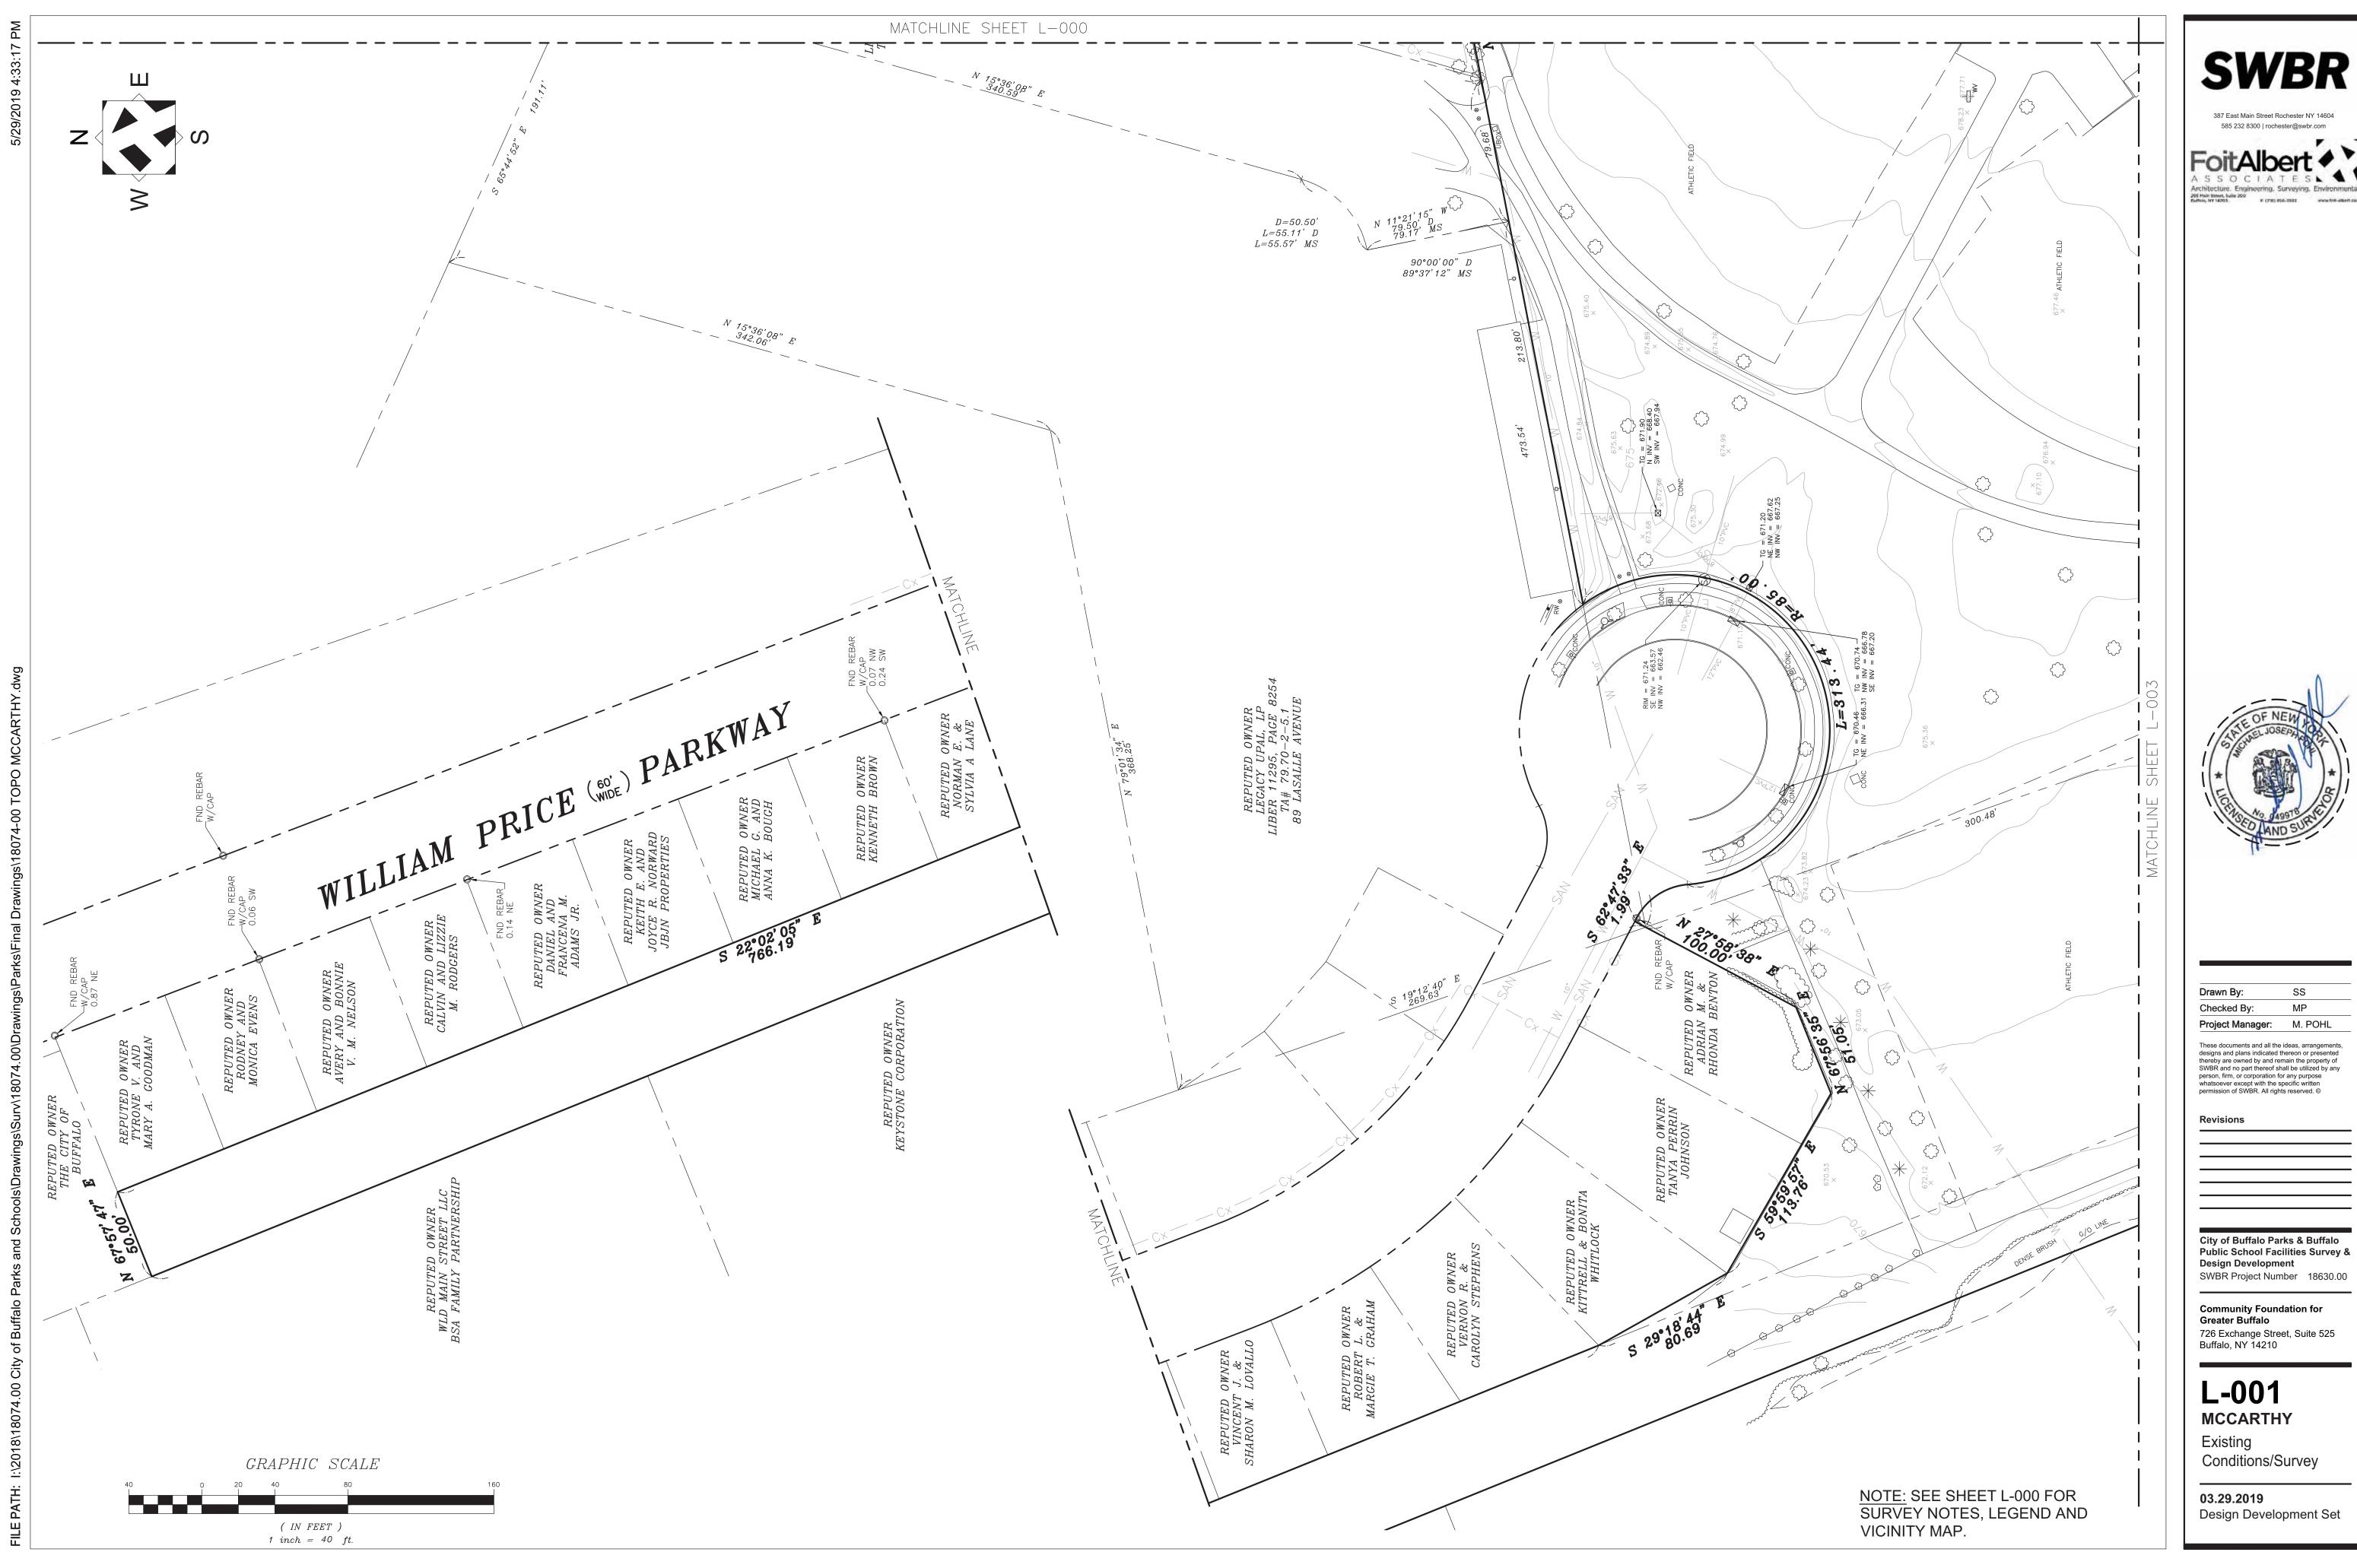

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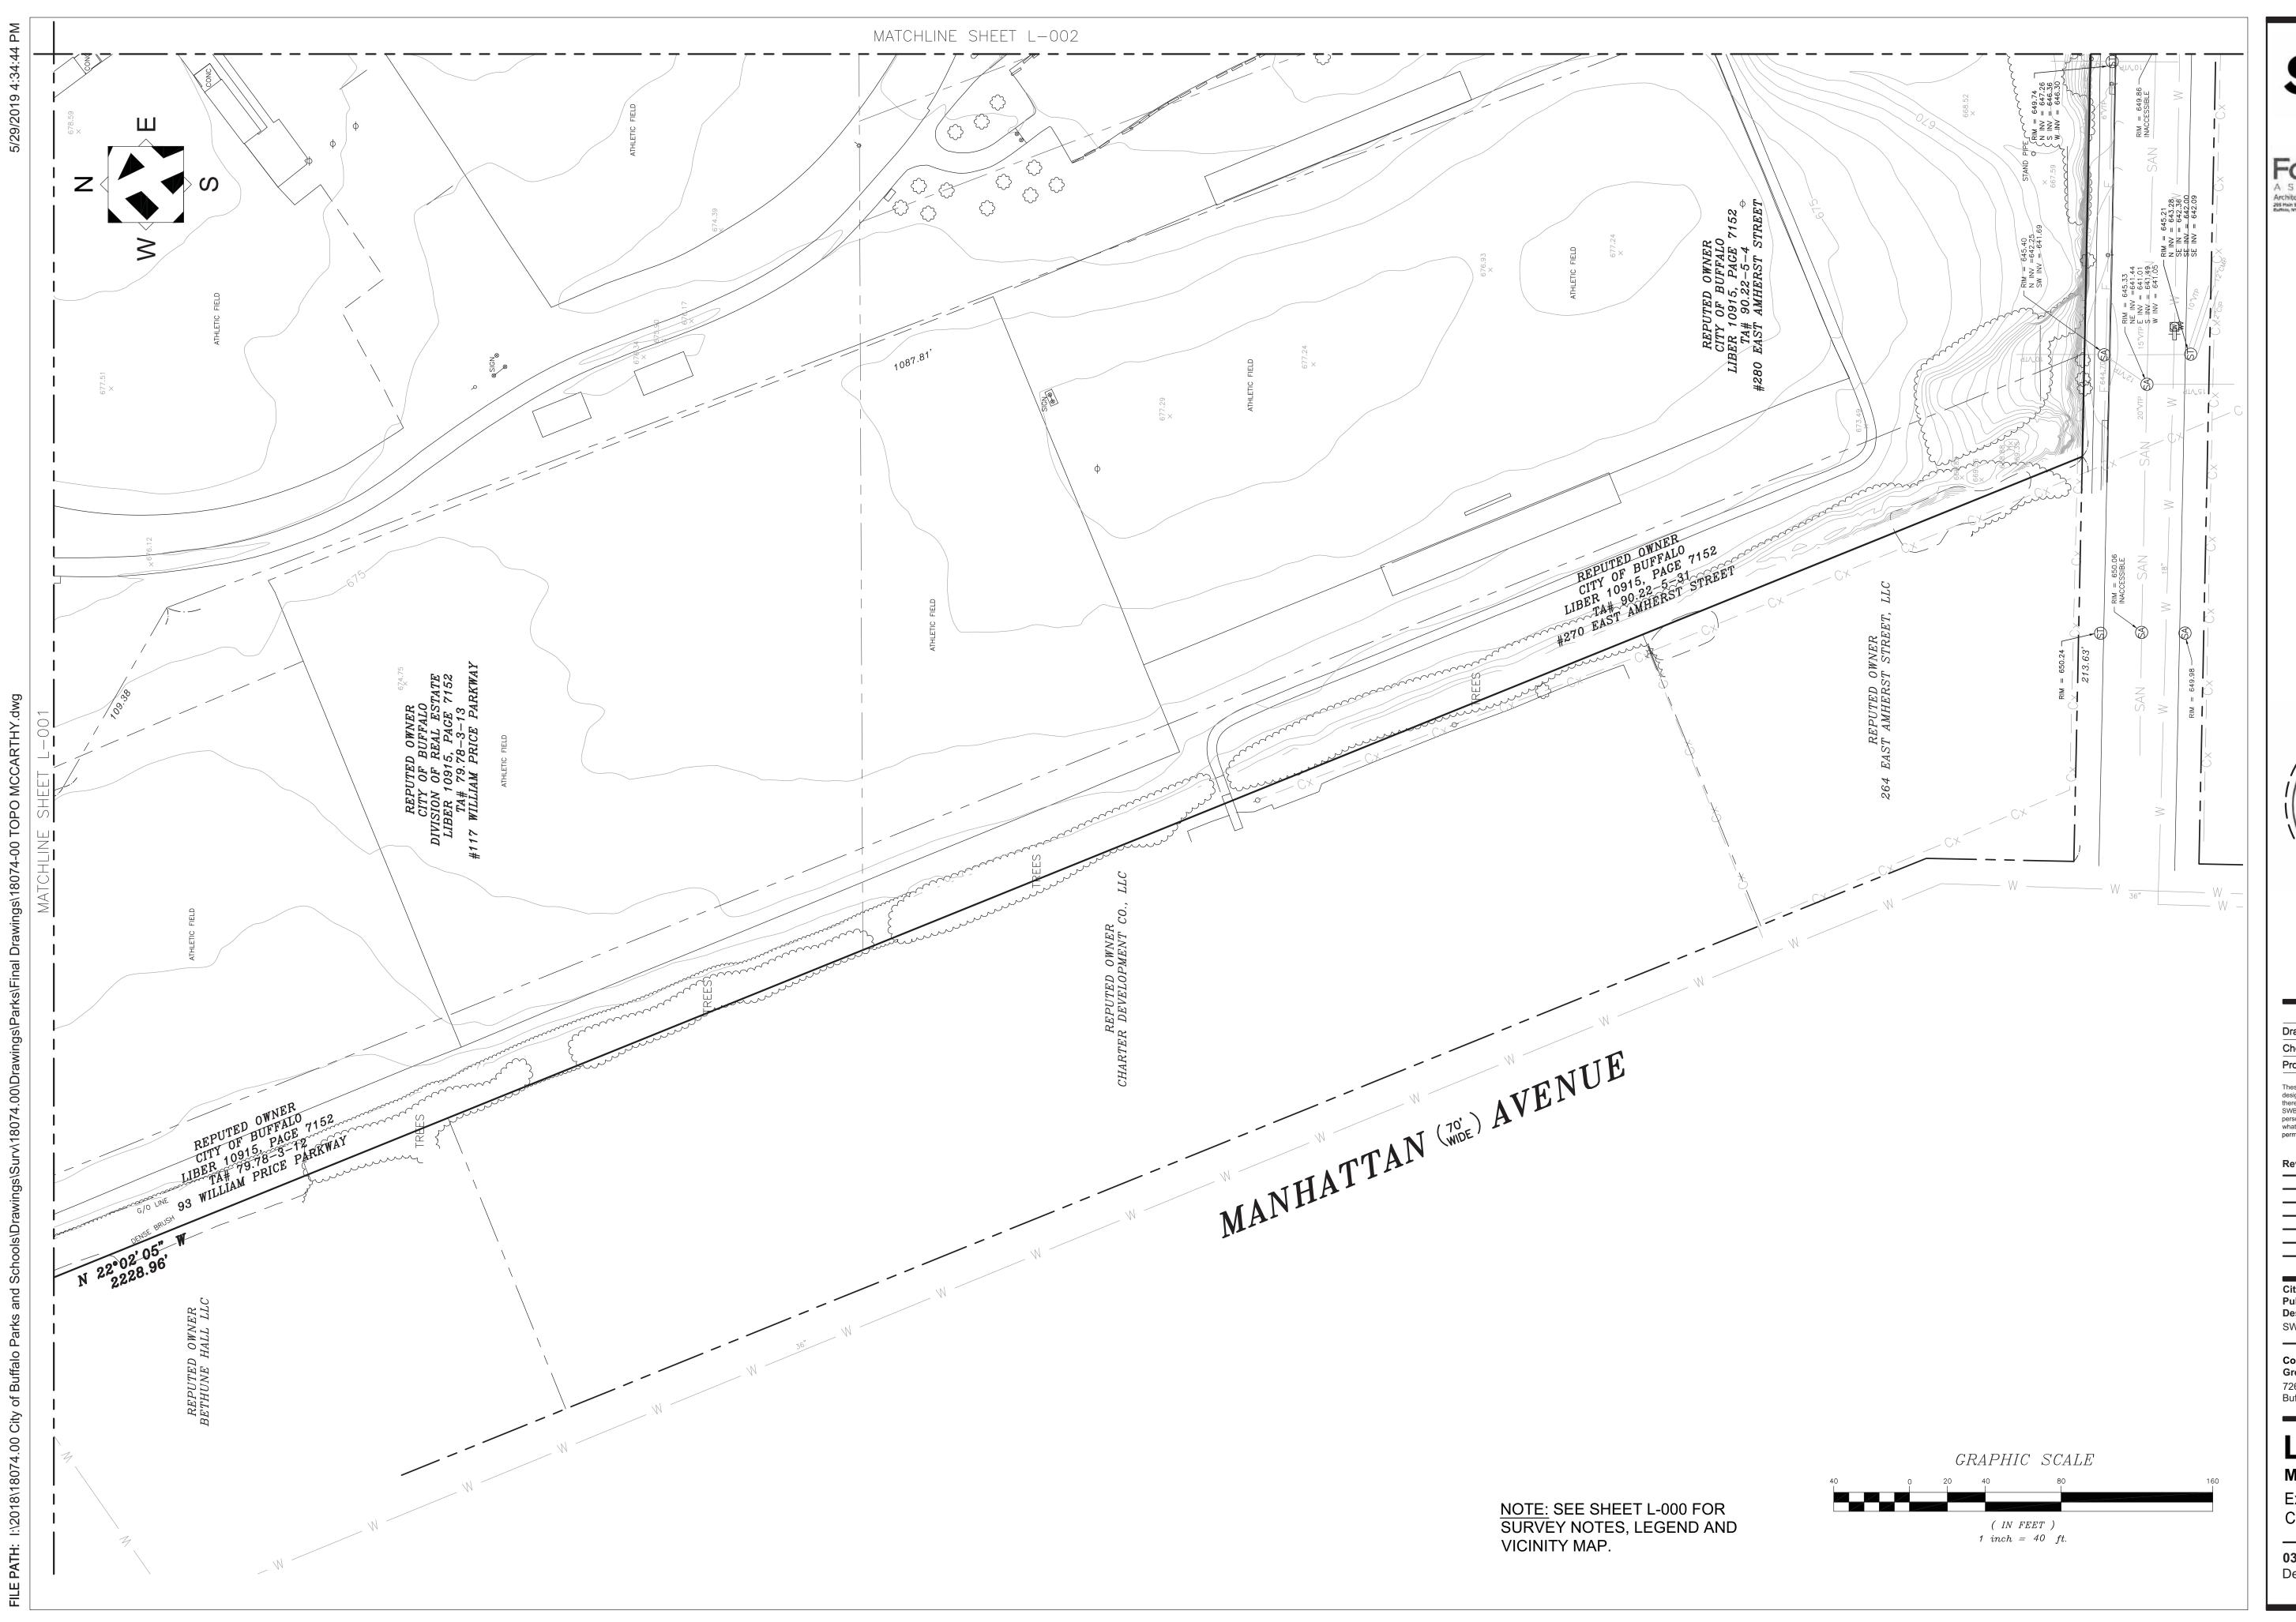
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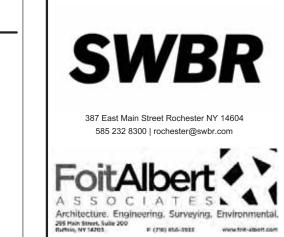
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L-002

Conditions/Survey

Design Development Set







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Checked By: MP
Project Manager: M. POHL

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Revisions

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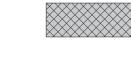
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L-003
MCCARTHY

Existing Conditions/Survey

McCARTHY DEMOLITION PLAN






DEMOLISH EXISTING BUILDING AND DISPOSE OFF SITE. CONCRETE FOUNDATIONS/WALLS/SLABS AND GRANULAR BASE MATERIALS TO BE REMOVED.



EXISTING PAVEMENT, CURBING, AND AGGREGATE BASE MATERIAL TO BE REMOVED AND DISPOSED OFF SITE.

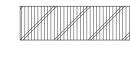

SURFACE MATERIAL (EWF), AND FOOTINGS TO BE REMOVED AND DISPOSED OFF SITE.

EXISTING PLAYGROUND EQUIPMENT, SAFETY



SITE ELEMENT TO BE REMOVED AND DISPOSED OFF SITE IN A LEGAL MATTER.



SAW CUT LINE



TREE TO REMAIN AND BE PROTECTED



TREE TO BE REMOVED

GENERAL DEMOLITION NOTES

- 1. CONTRACTOR TO REMOVE & DISPOSE OF ALL ITEMS INDICATED & ANY ITEMS INCIDENTAL TO THE CONSTRUCTION AS REQUIRED.
- 2. CONTRACTOR TO PROTECT/PRESERVE ALL EXISTING ITEMS TO REMAIN, INCLUDING BUT NOT LIMITED TO BUILDINGS, PAVEMENT, OVERHEAD & BURIED UTILITIES, TREES, LANDSCAPE, ETC. DAMAGE TO ITEMS SCHEDULED TO REMAIN SHALL BE REPAIRED OR REPLANTED AT NO ADDITIONAL COST TO THE OWNER.
- 3. UTILITIES SHOWN ARE APPROXIMATE. CONTRACTOR SHALL HAVE ALL UNDERGROUND FACILITIES LOCATED AND MARKED PRIOR TO
- EXCAVATION/DEMOLITION CONSTRUCTION. 4. REMOVE CONCRETE SIDEWALK AND/OR PAVEMENT TO THE LIMITES
- INDICATED. SAW CUT CONCRETE TO THE NEAREST EXISTING CONTROL/EXPANSION JOINT.
- 5. CONTRACTOR SHALL MARK TREES (DESIGNATED FOR REMOVAL) IN THE FIELD AND OBTAIN OWNER'S ON-SITE REPRESENTATIVE APPROVAL PRIOR TO BEGINNING REMOVALS.
- 6. CLEAR AND GRUB ALL VOLUNTEER VEGETATION, AS INDICATED. 7. ALL EXISTING SITE FURNITURE TO BE REMOVED AND DISPOSED OF UNLESS
- OTHERWISE NOTED.

NO.	DESCRIPTION
1	SALVAGE EXISTING PARK SIGN
2	REMOVE AND DISPOSE OF CHAIN LINK FENCE, POSTS, AND FOOTERS CLEAR AND GRUB VEGETATION.
3	REMOVE AND SALVAGE CHAIN LINK FENCE FABRIC, TOP, MIDDLE, AND BOTTOM RAILS (~20' HT). EXCAVATE POSTS, FOOTERS, AND MOW STRIP PAVEMENT. CLEAR AND GRUB ALL VEGETATION ALONG FENCE LINE.
4	REMOVE AN SALVAGE CHAIN LINK FENCE FABRIC, TOP AND BOTTOM RAILS. EXCAVATE ASPHALT MOW STRIP. FENCE POSTS TO REMAIN IN PLACE.
5	REMOVE EXISTING BOLLARD. REPLACE WITH CITY STANDARD LOCKABLE BOLLARD
6	BLEACHER TO BE SALVAGED FOR REUSE ON SITE
7	PROTECT IN-SITE EXISTING MEMORIAL STRUCTURE
8	EXISTING BATTING CAGE. REMOVE AND DISPOSE OF SYNTHETIC TURF AND WOOD FRAME BASE. STONE BASE AND STEEL COLUMNS TO REMAIN.
9	REMOVE AND DISPOSE OF EXISTING PLAY EQUIPMENT INCLUDING FOOTERS (SIZE ~ 18" DIA x 4' DEEP)
10	DEMOLISH AND DISPOSE OF EXISTING PT WOOD STAIRS
11	SALVAGE AND STOCKPOLE STONE BOULDERS FOR REUSE ON SITE
12	REMOVE GRASS AND WEEDS FROM WARNING TRACK
13	REMOVE AND LEGALLY DISPOSE OF MISC. DEBRIS FROM CITY PARK PROPERTY
14	REMOVE AND DISPOSE OF STEEL RIBBON GUIDERAIL POST AND CONCRETE FOOTERS
15	CLEAR AND GRUB ALL VEGETATION UNDER AND AROUND FENCE.
16	DEMOLISH (2) EXISTING BUILDINGS, REFER TO ARCHITECTURAL DRAWINGS
17	EXISTING CONCESSION BUILDING TO BE RENOVATED. REFER TO ARCHITECTURAL DRAWINGS.
18	CLEAR AND GRUB UNDERSTORY VEGETATION INCLUDING INVASIVE SPECIES, WEED AND OTHER EARLY SUCCESSIONAL PLANT MATERIALS. LANDSCAPE ARCHITECT TO TAG MATERIALS TO REMAIN.
19	CLEAR AND GRUB ALL VEGETATION TO TOP OF ROCK LEDGE / SLOPE ENTIRE WEST PROPERTY LINE.
20	REMOVE AND SALVAGE BENCH. EXCAVATE AND DISPOSE OF CONCRETE PAD.
21	REMOVE AND SALVAGE EXISTING LOCKABLE BOLLARDS FOR REUSE
22	SALVAGE EXISTING SCOREBOARD
23	SALVAGE EXISTING FLAGPOLE
24	REMOVE AND DISPOSE OF 4 TIER BLEACHER
25	FILL EROSION GULLY



SWBR 387 East Main Street Rochester NY 14604 585 232 8300 | rochester@swbr.com

Drawn By: Checked By: Project Manager: BP

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Revisions

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Community Foundation for Greater Buffalo

SWBR Project Number 18630.00

726 Exchange Street, Suite 525 Buffalo, NY 14210

L-004 **McCarthy Demolition Plan**

387 East Main Street Rochester NY 14604

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Site Layout Plan

Design Development Set

MCCARTHY SITE LAYOUT PLAN (SOUTH)



SWBR

387 East Main Street Rochester NY 14604

585 232 8300 | rochester@swbr.com

Drawn By: MMF
Checked By: BP
Project Manager: BP

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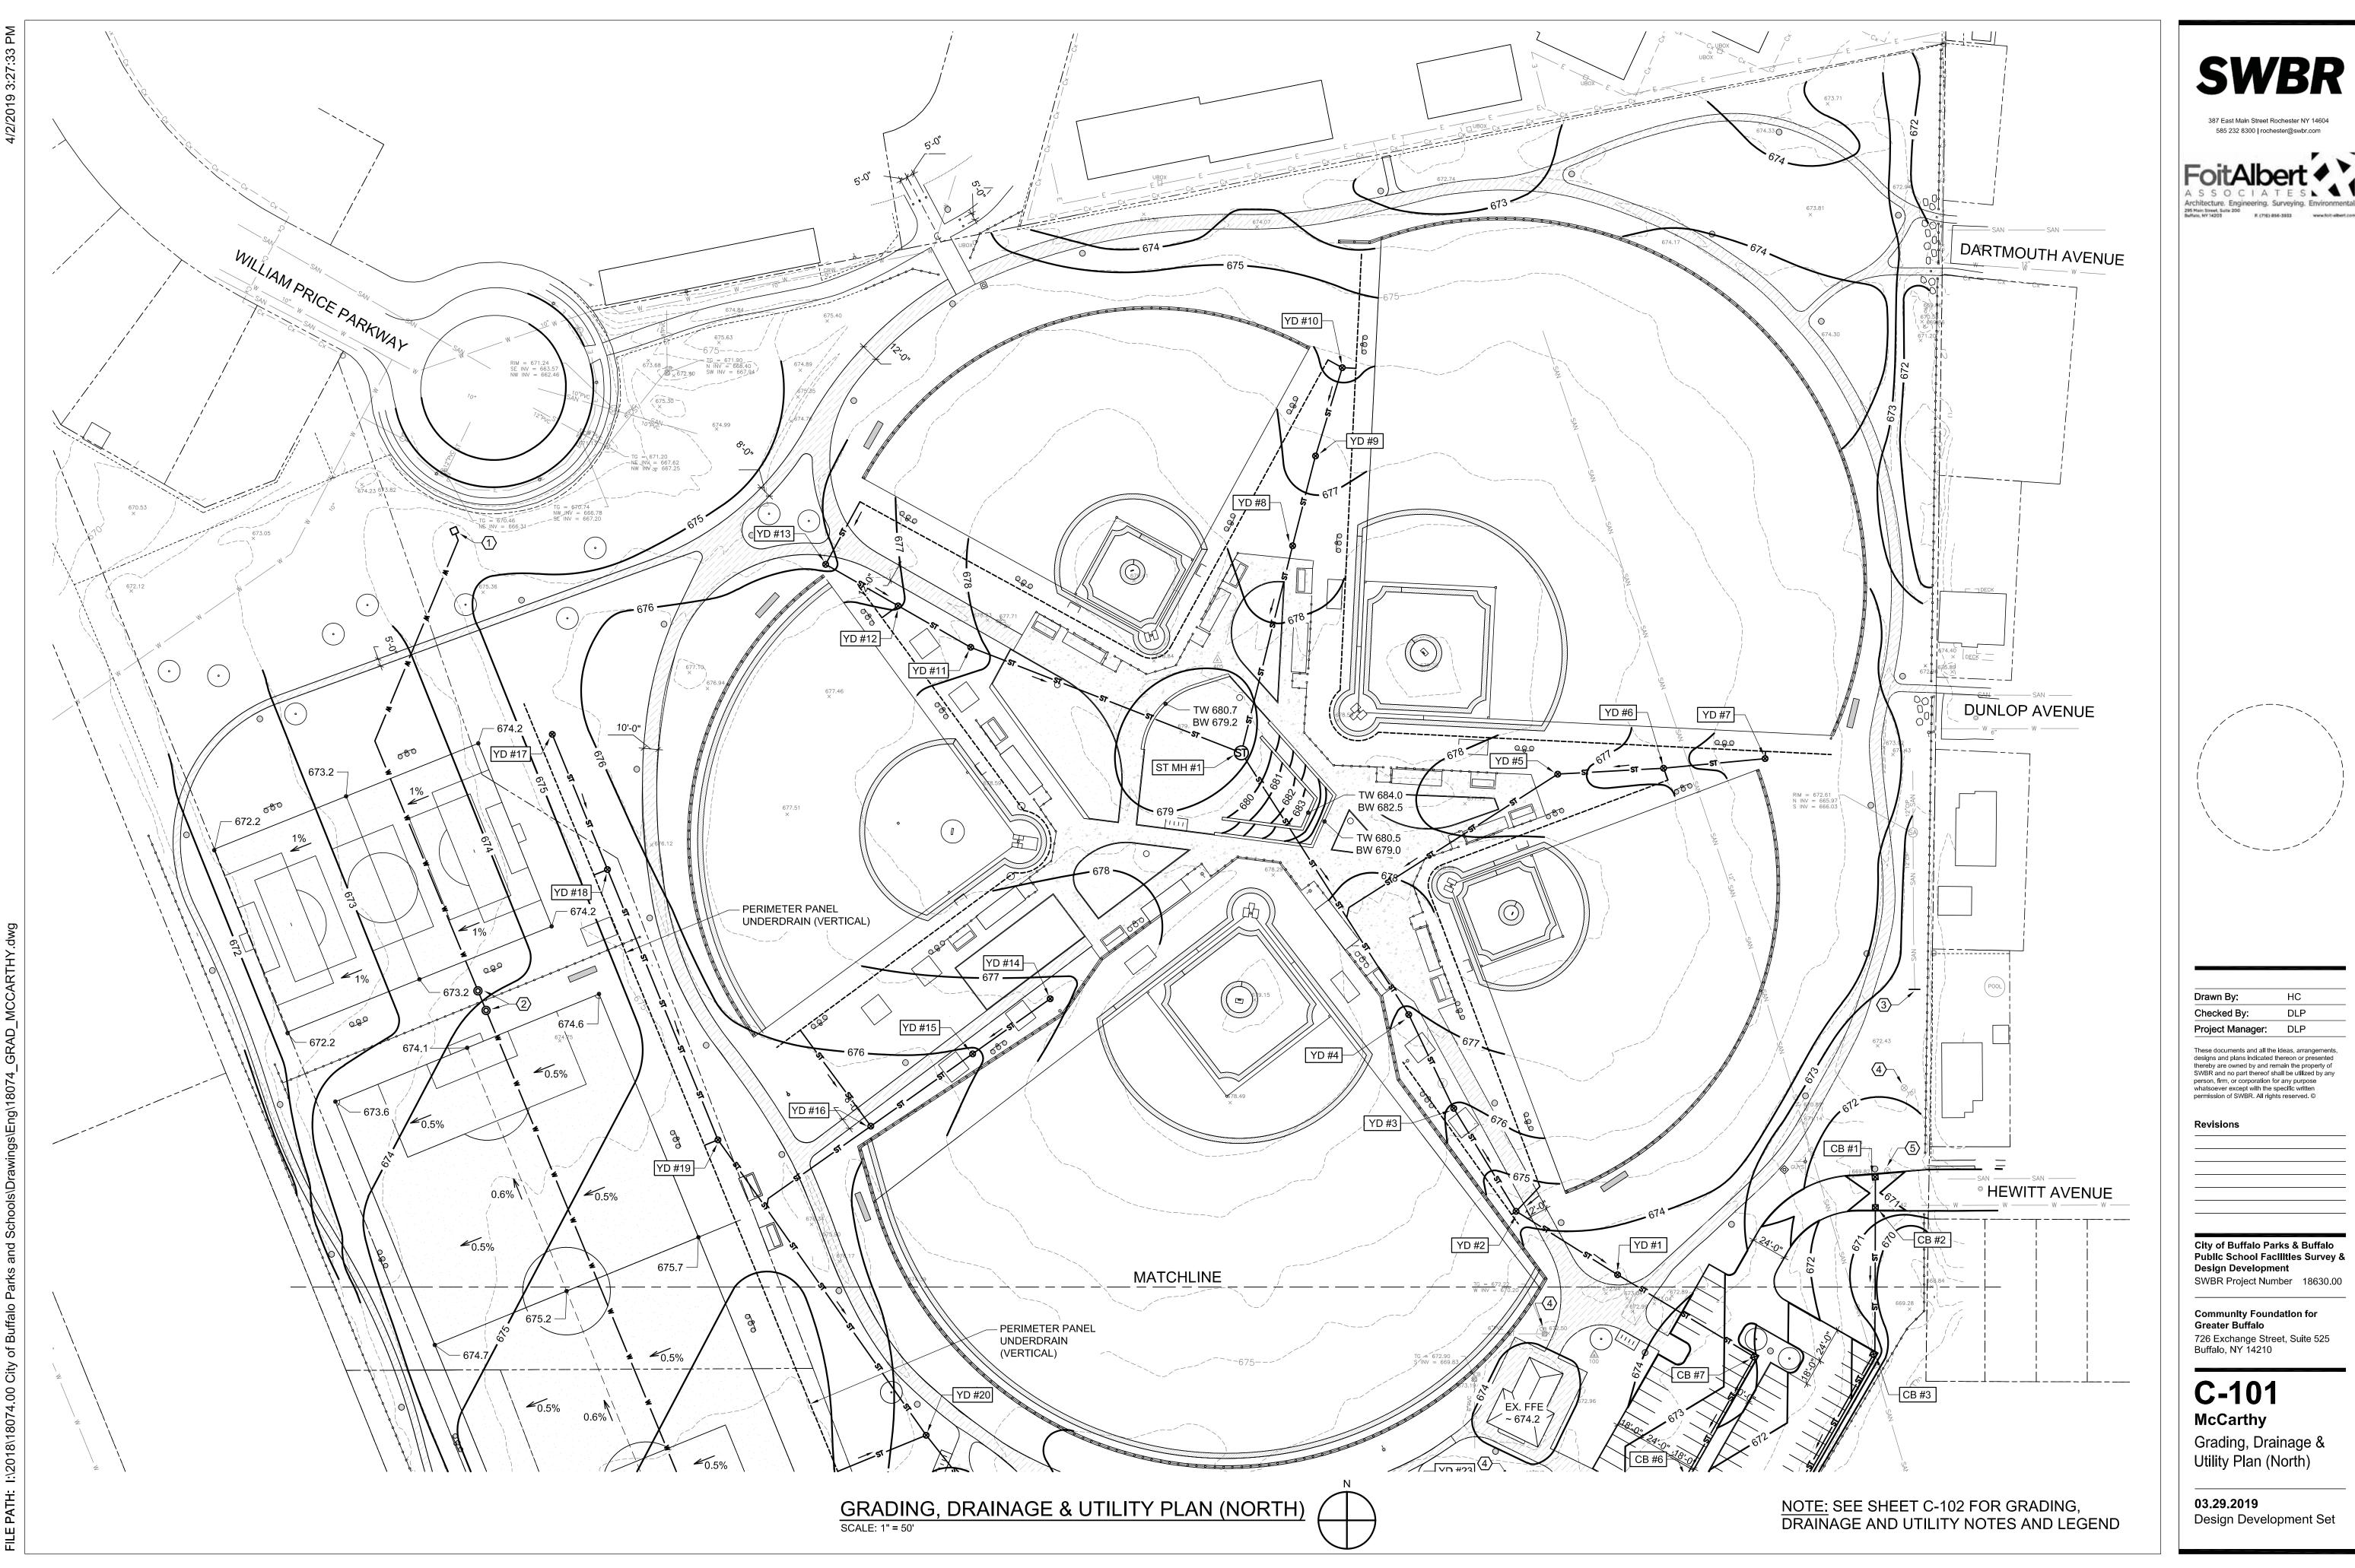
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Community Foundation for Greater Buffalo 726 Exchange Street, Suite 525

726 Exchange Street, Suite 525 Buffalo, NY 14210

L-102 McCarthy

Site Layout Plan (South)



387 East Main Street Rochester NY 14604 585 232 8300 | rochester@swbr.com

Checked By: DLP Project Manager: DLP

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City of Buffalo Parks & Buffalo Public School Facilities Survey & Design Development

Community Foundation for Greater Buffalo

726 Exchange Street, Suite 525 Buffalo, NY 14210

C-101 **McCarthy**

Grading, Drainage & Utility Plan (North)



GRADING & UTILITY NOTES

- STORM PIPING TO BE HDPE UNLESS OTHERWISE INDICATED.
 SANITARY SEWER PIPING TO BE SDR-35 PVC. WATER PIPING TO
 BE TYPE K COPPER OR DUCTILE IRON. PIPE SIZING TO BE
 DETERMINED DURING FINAL DESIGN.
- ALL UNDERDRAIN PIPING TO BE 4" DIAMETER PERFORATED HDPE OR PANEL UNDERDRAIN AS INDICATED ON PLANS. UNDERDRAIN AND PANEL DRAIN PIPE TO SLOPE TOWARD CONNECTIONS TO STORM SYSTEM.
- 3. THE PROJECT MAY BE SUBJECT TO THE REQUIREMENTS OF NYSDEC SPDES GENERAL PERMIT FOR STORMWATER DISCHARGES FROM CONSTRUCTION ACTIVITY, GP-0-15-002. A STORMWATER POLLUTION PREVENTION PLAN (SWPPP) IS REQUIRED FOR THE PROJECT AS WELL AS EROSION AND SEDIMENT CONTROL PLANS PREPARED IN ACCORDANCE WITH THE "NEW YORK STATE STANDARDS AND SPECIFICATIONS FOR EROSION AND SEDIMENT CONTROL."
- 4. STORMWATER MANAGEMENT SYSTEM (WATER QUANTITY AND QUALITY MEASURES) TO BE DESIGNED TO MEET SWPPP REQUIREMENTS DURING FINAL DESIGN.

	UTILITY KEY NOTES
1	CONNECT NEW WATER SERVICE TO EX. WATER SERVICE FROM HOT BOX
2	NEW YARD HYDRANT TO CONNECT TO NEW WATER LINE
3	12" EX. ASBESTOS CEMENT SEWER PIPE TO BE REPLACED WHERE PIPE HAS COLLAPSED
4	ADJUST EX. CATCH BASIN OR YARD DRAIN TO FINISH GRADE
(5)	REMOVE EX. CATCH BASIN OR YARD DRAIN
6	OUTLET STORM PIPE TO EX. BUFFALO SEWER AUTHORITY PROPERTY, INV ELEV ~664.0
7	OUTLET STORM PIPE TO EX. COMBINED SEWER


STORM DRAINAGE STRUCTURES

I.D.	DESCRIPTION	RIM	INVER
ST MH #1	STORM MANHOLE	679.0	672.0
CB #1	CATCH BASIN	670.6	667.6
CB #2	CATCH BASIN	670.6	667.4
CB #3	CATCH BASIN	670.6	666.9
CB #4	CATCH BASIN	670.6	666.2
CB #5	CATCH BASIN	670.0	664.3
CB #6	CATCH BASIN	672.0	668.6
CB #7	CATCH BASIN	672.5	669.1
CB #8	CATCH BASIN	670.0	665.0
CB #9	CATCH BASIN	669.1	665.3
CB #10	CATCH BASIN	669.3	666.3
CB #11	CATCH BASIN	670.8	667.8
CB #12	CATCH BASIN	672.3	668.9
CB #13	CATCH BASIN	664.8	661.3
CB #14	CATCH BASIN	665.3	661.8
YD #1	YARD DRAIN	673.0	669.7
YD #2	YARD DRAIN	674.2	670.1
YD #3	YARD DRAIN	675.9	670.5
YD #4	YARD DRAIN	676.9	670.9
YD #5	YARD DRAIN	677.2	673.0
YD #6	YARD DRAIN	676.3	673.4
YD #7	YARD DRAIN	675.5	673.8
YD #8	YARD DRAIN	677.4	672.7
YD #9	YARD DRAIN	676.7	673.0
YD #10	YARD DRAIN	675.8	673.3
YD #11	YARD DRAIN	677.8	672.8
YD #12	YARD DRAIN	677.0	673.1
YD #13	YARD DRAIN	675.9	673.4
YD #14	YARD DRAIN	676.7	674.2
YD #15	YARD DRAIN	675.9	673.4
YD #16	YARD DRAIN	675.1	672.6
YD #17	YARD DRAIN	675.3	672.8
YD #18	YARD DRAIN	675.3	672.3
YD #19	YARD DRAIN	675.5	671.3
YD #20	YARD DRAIN	674.3	670.1
YD #21	YARD DRAIN	672.5	668.5
YD #22	YARD DRAIN	672.5	668.2
YD #23	YARD DRAIN	672.5	667.8
YD #24	YARD DRAIN	672.5	667.4
YD #25	YARD DRAIN	672.4	667.1
YD #26	YARD DRAIN	672.4	666.8
YD #27	YARD DRAIN	665.5	662.5



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Drawn By: HC
Checked By: DLP
Project Manager: DLP

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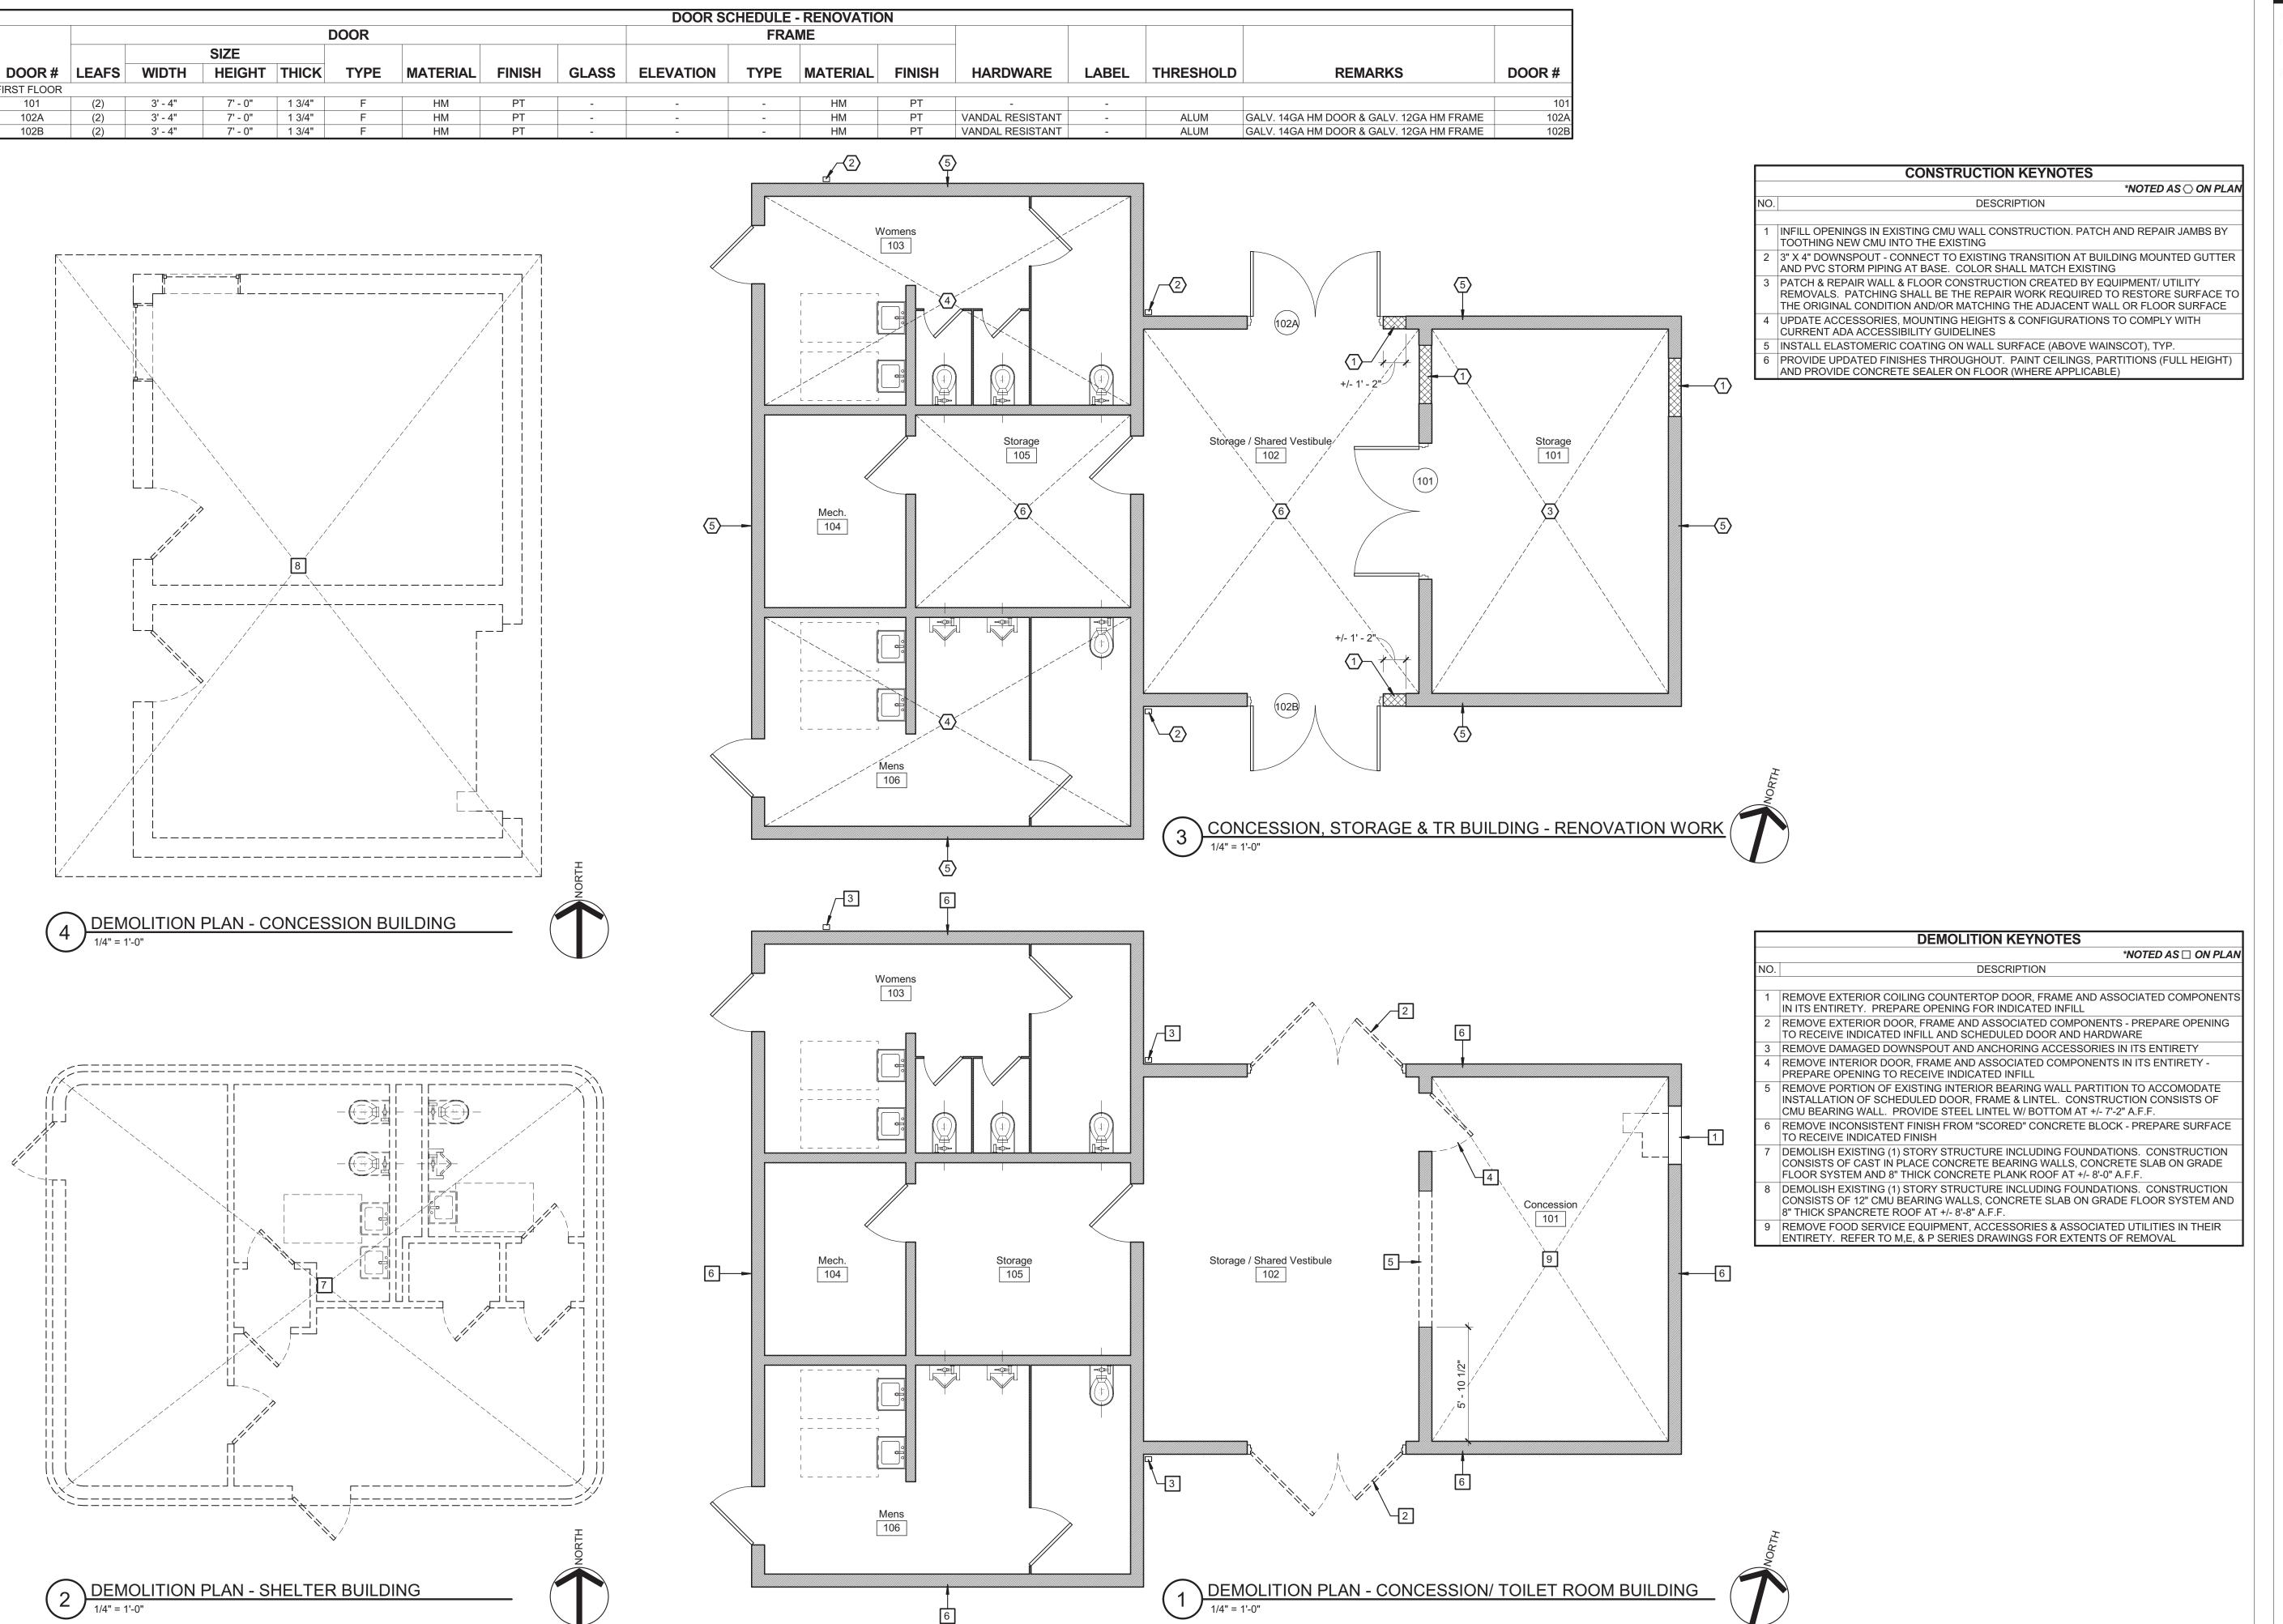
evisions

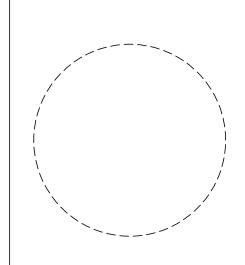City of Buffalo Parks & Buffalo Public School Facilities Survey & Design Development SWBR Project Number 18630.00

Community Foundation for Greater Buffalo 726 Exchange Street, Suite 525 Buffalo, NY 14210

C-102
McCarthy

Grading, Drainage & Utility Plan (South)



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Drawn By: JMB
Checked By: JMB
Project Manager: DP

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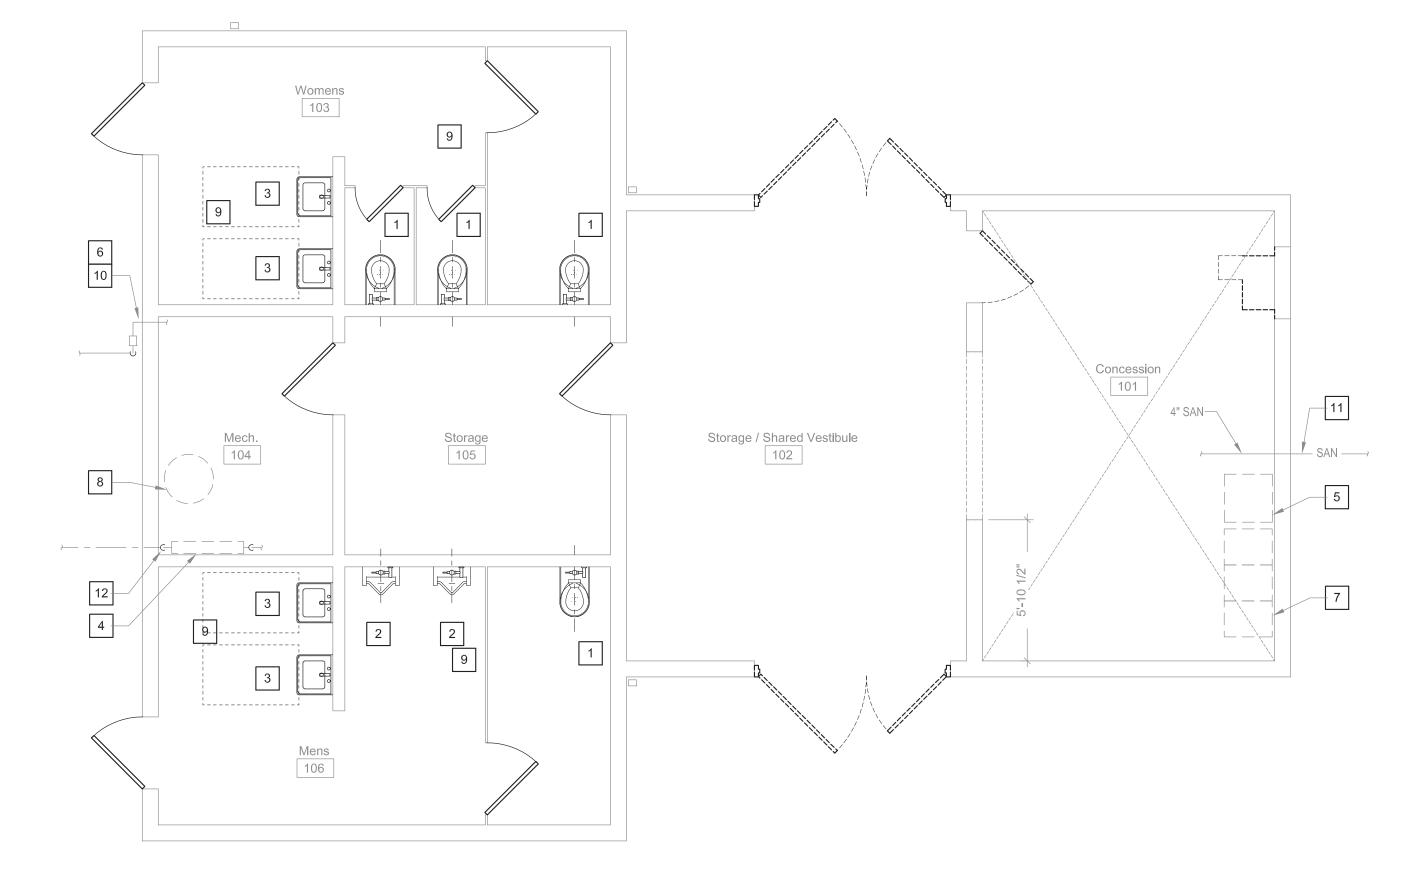
Revisions

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Community Foundation for Greater Buffalo 726 Exchange Street, Suite 525 Buffalo, NY 14210

A-101
McCarthy

Concession Building Renovations



1 FIRST FLOOR PLAN - TICKET BOOTHS & CONCESSION STAND



KEYED DRAWING NOTES: #

- REMOVE WATER CLOSET, 4" SAN., 2" V. & 1" C. BRANCH PIPING BACK TO MAINS.
 REMOVE LAVATORY, CARRIER, 1½" SAN., 1½" V. & ½" C. BRANCH PIPING BACK TO MAINS.
- 3. REMOVE URINAL, 2" SAN., 2" V. & $\frac{1}{2}$ " C. PIPING BACK TO MAINS.
- 4. REMOVE RPZ AND 2" PIPING BACK TO FLOOR AND CAP 2" C. ABOVE FLOOR.
- 5. REMOVE GREASE TRAP AND 2" SAN. PIPING TO SINK DRAIN.6. EXISTING 2" GAS PIPING TO REMAIN.
- 7. EXISTING 3 BASIN STAINLESS STEEL SINK TO REMAIN. REMOVE FAUCETS AND DRAINS. DISCONNECT AND REMOVE SINK FROM WALL.
- 8. REMOVE WATER HEATER.
- 9. REMOVE FLOOR DRAIN AND TRAP.10. GAS METER BY NATIONAL FUEL TO REMAIN.
- 10. GAS METER BY NATIONAL FUEL TO REMAIN11. EXISTING SANITARY SEWER TO REMAIN.

SERVING KITCHEN

SERVING KITCHENS ARE LIMITED TO "SERVING USE" WHERE THE USERS BRING THEIR OWN FOOD, MATERIALS AND UTENSILS AND LEAVE THE SITE WITH THEIR MATERIALS. ITEMS PROVIDED IN THE BUILDING ARE LIMITED TO COUNTERS AND SINKS FOR CLEANUP TO INCLUDE A 3-BASIN SINK MINIMUM. 3-BASIN SINKS REQUIRE A GREASE INTERCEPTOR DEVICE PER THE INTERNATIONAL PLUMBING CODE, CITY OF BUFFALO PLUMBING DEPARTMENT AND HEALTH CODES.

ADDITIONAL "SERVING KITCHEN" ITEMS INCLUDE PROVIDING WORKTABLES, COUNTERS, SOME CASEWORK FOR STORAGE AND A SINK FOR HAND WASHING.


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WATTS

ARCHITECTURE &
ENGINEERING

95 Perry Street, Suite 300
Buffalo, New York 14203
p: 716,206,5100 f. 716,206,5199



Drawn By:	MPC
Checked By:	MJS
Project Manager:	RCP
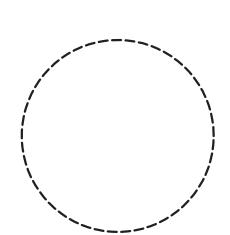
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PD-101

McCarthy Park
PLUMBING FIRST
FLOOR PLAN DEMOLITION

KEYED NOTES (#)

1. PROVIDE FLOOR MOUNTED WATER CLOSET. PROVIDE 1" C., 2" V. & 4" SAN. BRANCH PIPING.

2. PROVIDE URINAL. PROVIDE $\frac{3}{4}$ " C., 2" V. & 2" SAN. PIPING. 3. PROVIDE LAVATORY. PROVIDE $\frac{1}{2}$ " C., $\frac{1}{2}$ " H., $\frac{1}{2}$ " V. & $\frac{1}{2}$ " SAN. PIPING.

4. PROVIDE NEW SELF DRAINING 2" MUELLER OR CITY OF BUFFALO DIVISION OF WATER APPROVED EQUAL CURB STOP COCK VALVE AND 2" COPPER SPOOL PIECE CONNECT 2" C. TO EXISTING 2" C. AT THIS POINT

COPPER SPOOL PIECE. CONNECT 2" C. TO EXISTING 2" C. AT THIS POINT.

5. PROVIDE GREASE INTERCEPTOR AND FLOW CONTROL DEVICE.

GAS METER AND SERVICE BY NATIONAL FUEL.
 PROVIDE 3 BASIN STAINLESS STEEL SINK AGAINST WALL.

8. PROVIDE ELECTRIC WATER HEATER.

PROVIDE FLOOR DRAIN WITH DEEP SEAL TRAP, TRAP PRIMER, 4" SAN., 2" V. & ½" C PIPING. EXTEND ½" C. TO COLD WATER TRAP PRIMER.

10. PROVIDE 2" REDUCED PRESSURE ZONE BACKFLOW PREVENTION DEVICE.11. PROVIDE 2" DOMESTIC WATER METER WITH INTEGRAL STRAINER IN COMPLIANCE WITH BUFFALO DIVISION OF WATER REQUIREMENTS.

12. PROVIDE PEDESTAL EMERGENCY EYEWASH WITH ½" C. AND ½" H. TO MIXING VALVE AND 1½" SAN. REFER TO 12/P1-3

13. 4" SANITARY SEWER.

BUILDINGS TO BE RENOVATED

NEW SCHEDULE 40 SOLID CORE PVC SANITARY SEWERS SHALL BE PROVIDED BELOW THE FLOOR SLAB AND EXTENDED TO THE NEAREST SANITARY SITE MANHOLE. A NEW TYPE L COPPER OR DUCTILE IRON WATER SERVICE SHALL BE EXTENDED FROM THE CITY STREET MAIN TO THE BUILDING. THE WATER SERVICE SHALL ENTER THE BUILDING THROUGH THE FOUNDATION WALL AND FLOOR SLAB AND BE LOCATED NEAR AN EXTERIOR WALL. A NEW PVC SANITARY SEWER WILL BE EXTENDED FROM THE BUILDING TO THE SITE SANITARY SEWER MANHOLE OR THE STREET MANHOLE. WHICHEVER IS CLOSEST.

GAS SERVICE: A NEW METER SET AND GAS SERVICE SIZED TO MATCH ANY BUILDING EQUIPMENT LOADS WILL BE PROVIDED BY NATIONAL FUEL. THE SERVICE WILL EXTEND FROM THE STREET MAIN TO THE METER LOCATION AT THE BUILDING WALL. SCHEDULE 40 STEEL GAS PIPE EXTENDED TO ANY WATER HEATING, KITCHEN OR BUILDING HEATING EQUIPMENT INSIDE.

NEW PLUMBING FIXTURES INCLUDING WATER CLOSETS, URINALS, LAVATORIES, SINKS, MOP SERVICE SINKS, AND SHOWERS IF REQUIRED WILL BE PROVIDED. PLUMBING SPECIALTIES INCLUDING FLOOR DRAINS, FLOOR CLEANOUTS, GREASE INTERCEPTORS, WATER HAMMER ARRESTORS AND WALLS HYDRANTS WILL BE PROVIDED. ELECTRIC OR GAS WATER HEATERS SIZED TO SERVE THE FIXTURE AND EQUIPMENT LOADS WILL BE PROVIDED. REQUIRED SAFETY DEVICES SUCH AS EYEWASHES WILL BE PROVIDED FOR BUILDINGS INCLUDING KITCHENS OR WATER TREATMENT EQUIPMENT FOR SWIMMING POOLS.

WATER SERVICE ENTRANCE: A NEW WATER SERVICE WILL BE EXTENDED TO THE BUILDING FROM THE STREET WATER MAIN. A NEW METER SET WILL BE LOCATED AS PART OF A NEW WATER SERVICE ENTRANCE IN THE INTERIOR OF THE BUILDING, INSTALLED ADJACENT TO AN EXTERIOR WALL AND FITTED WITH A REDUCED PRESSURE ZONE BACKFLOW DEVICE. A WATER METER COMPLYING WITH THE CITY OF BUFFALO DIVISION OF WATER REQUIREMENTS WILL BE PROVIDED. A REDUCED PRESSURE ZONE BACKFLOW PREVENTION DEVICE WILL BE PROVIDED ON THE DOMESTIC WATER SERVICE DOWNSTREAM OF THE METER AND IN COMPLIANCE WITH THE CITY OF BUFFALO AND NEW YORK STATE HEALTH DEPARTMENT CODE REQUIREMENTS.

APPLICATIONS FOR ALL UTILITY SERVICES WILL BE REQUIRED TO THE RESPECTIVE UTILITIES FOR THE GAS, ELECTRIC, WATER SERVICE, DOMESTIC WATER BACKFLOW PREVENTION AND SANITARY SEWER SYSTEMS. APPLICATIONS AND DESIGN SUBMISSIONS MUST INCLUDE CAPACITIES AND DEMONSTRATION OF CODE COMPLIANCES. APPLICATIONS INCLUDE THE ADDED DISCHARGE CAPACITY TO THE CITY SANITARY SEWER SYSTEM, WATER SERVICES AND GAS INCLUDE DESIGN SUBMISSIONS FOR APPROVAL, TAPPING PERMITS BY CONTRACTORS AND FINAL INSPECTION APPROVALS.

THE CONTRACTOR SHALL PROVIDE FOR THE COORDINATION AND THE TIMING OF UTILITY INSTALLATIONS WITH UTILITY AGENCIES. THE CONTRACTOR SHALL PROVIDE FOR CONTACT, APPLICATION AND ALL COST ASSOCIATED WITH REMOVAL WORK AND COMPLETE THE WORK IN COMPLIANCE WITH EACH AGENCIES WRITTEN REQUIREMENTS. CONTACTS SHALL INCLUDE THE BUFFALO DIVISION OF WATER, BUFFALO SEWER AUTHORITY AND NATIONAL FUEL.

EXCAVATION, PIPE BEDDING AND BACKFILL WILL BE REQUIRED FOR WATER AND SEWER UTILITIES.

SERVING KITCHEN


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ADDITIONAL "SERVING KITCHEN" ITEMS INCLUDE PROVIDING WORKTABLES, COUNTERS, SOME CASEWORK FOR STORAGE AND A SINK FOR HAND WASHING.

387 East Main Street Rochester NY 14604
585 232 8300 | rochester@swbr.com

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ARCHITECTURE &
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Drawn By:	MPC
Checked By:	MJS
Project Manager:	RCP

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P-101

McCarthy Park
PLUMBING FIRST
FLOOR PLAN

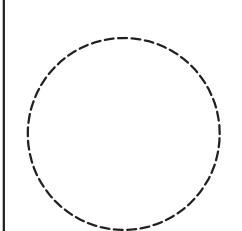3.29.2019
Design Development

1) FIRST FLOOR PLAN - TICKET BOOTHS & CONCESSION STAND

HVAC GENERAL NOTES LIST

- A. CONTRACTOR IS RESPONSIBLE FOR PROPER FIELD FITTING AND QUANTITY OF WORK. CONTRACTOR SHALL TAKE FIELD MEASUREMENTS AS REQUIRED AND BE RESPONSIBLE FOR FITTING NEW CONSTRUCTION TO EXISTING CONSTRUCTION. CONTRACTOR SHALL BE RESPONSIBLE TO REPAIR ANY EXISTING CONDITIONS DISTURBED OR DAMAGED DURING CONSTRUCTION (TO MATCH EXISTING).
- B. CONTRACTOR IS RESPONSIBLE FOR SITE INVESTIGATION PRIOR TO START OF WORK TO REVEAL EXISTING CONDITIONS.
- C. IT IS THE CONTRACTOR'S RESPONSIBILITY TO EXAMINE ALL DRAWINGS AND SPECIFICATIONS AND COORDINATE WORK WITH ALL OTHER TRADES.
- D. PROVIDE ALL CUTTING, PATCHING AND FIRE STOPPING REQUIRED TO ACCOMPLISH WORK SHOWN. PATCH AND SEAL OPENINGS TO MATCH ADJACENT EXISTING WALLS, FLOORS, CEILINGS, ETC. UNLESS OTHERWISE INDICATED. CONCEAL ALL WORK IN FINISHED AREAS UNLESS OTHERWISE INDICATED OR DIRECTED BY THE ARCHITECT.
- E. CONTRACTOR SHALL FIELD VERIFY ALL LOCATIONS, DIMENSIONS AND EXISTING CONDITIONS (PIPING, DUCTWORK, EQUIPMENT, STRUCTURAL ELEMENTS, ETC.) PRIOR TO STARTING WORK. CONTRACTOR SHALL COORDINATE INSTALLATION OF EQUIPMENT, PIPING, AND DUCTWORK WITH EXISTING CONDITIONS AND OTHER TRADES. PROVIDE FITTINGS, TRANSITIONS, OFFSETS, ELEVATION CHANGES, ETC. TO MINIMIZE CONFLICTS WITH EXISTING CONDITIONS.
- F. CONTRACTOR SHALL COORDINATE CONNECTIONS TO ALL MECHANICAL EQUIPMENT.

AMPERE(S)

EXISTING

EXTERNAL

EXT

- G. DRAWINGS ARE SCHEMATIC, AND SERVE TO INDICATE THE TYPE AND LOCATION OF MAJOR PIECES OF EQUIPMENT. THIS CONTRACTOR SHALL PROVIDE AND INSTALL ALL MATERIALS, EQUIPMENT, AND LABOR NECESSARY FOR A COMPLETE AND FIRST CLASS INSTALLATION. ADJUST THE LOCATION OF ALL DUCTWORK, PIPING, WIRING, EQUIPMENT, AND CONNECTIONS TO ACCOMMODATE ACTUAL CONSTRUCTION CONDITIONS ENCOUNTERED; OBTAIN APPROVAL FROM THE ENGINEER FOR ALL BUT MINOR CHANGES. IN ALL CASES EQUIPMENT AND DEVICES SHALL BE FULLY ACCESSIBLE AND MAINTAINABLE.
- H. INSTALL ALL EQUIPMENT AND SYSTEMS IN COMPLETE COMPLIANCE WITH GOVERNING CODES, MANUFACTURERS INSTALLATION INSTRUCTIONS, AND SPECIFICATIONS.
- I. ALL PHYSICAL ATTRIBUTES OF EQUIPMENT AND DEVICES ARE BASED ON THOSE MANUFACTURERS LISTED IN THE SPECIFICATIONS AND/OR THE EQUIPMENT SCHEDULES. THE RESPECTIVE CONTRACTORS ARE RESPONSIBLE FOR ALL CHANGES AND ASSOCIATED COSTS BROUGHT ABOUT BY THE USE OF ITEMS BY OTHER MANUFACTURERS. THE ARCHITECT/ENGINEER HAS RESERVED THE RIGHT TO REJECT ITEMS BY OTHER MANUFACTURERS FOR REASONS INCLUDING, BUT NOT LIMITED TO, THOSE ITEMS NOT MATCHING THE PHYSICAL ATTRIBUTES OF THE MANUFACTURERS LISTED.
- J. THE EXISTING MECHANICAL SYSTEMS, OR PORTIONS THEREOF, SHALL REMAIN IN SERVICE THROUGHOUT CONSTRUCTION. ALL SYSTEM INSTALLATIONS AND EXISTING SYSTEM DEMOLITION SHALL BE COORDINATED TO MINIMIZE SYSTEM DOWNTIME.
- PROVIDE ANY AND ALL NECESSARY TEMPORARY SERVICES TO ADEQUATELY CONDITION THE BUILDING DURING ALL PHASES OF CONSTRUCTION. SCHEDULE SYSTEMS SHUTDOWNS WITH OWNER, SYSTEM SHUTDOWNS SHALL NOT INTERFERE WITH BUILDING OPERATIONS.
- .. COORDINATE PIPE & DUCT INSTALLATION WITH ELECTRICAL DEVICES. DO NOT INSTALL PIPING OR DUCTWORK IN PROHIBITED LOCATIONS SUCH AS ABOVE ELECTRICAL PANELS, WITHIN HIGH VOLTAGE ROOMS, ETC. COMPLY WITH NEC REQUIREMENTS.
- M. REFER TO ARCHITECTURAL REFLECTED CEILING PLAN DRAWINGS FOR DIFFUSER AND REGISTER LOCATIONS WITH RESPECT TO OTHER ELEMENTS.
- N. CAP ALL DUCT OPENINGS AND OPEN ENDED PIPING CREATED BY REMOVALS WORK. THIS APPLIES TO THOSE ITEMS NOT IDENTIFIED FOR REUSE.

HVAC ABBREVIATIONS LIST

A/C ACCU ACU AD ADA ADJ AFF AFR AFUE AHU APD AVG AWT	AIR CONDITIONING AIR COOLED CONDENSING UNIT AIR CONDITIONING UNIT ACCESS DOOR AMERICANS WITH DISABILITIES ACT ADJUSTABLE ABOVE FINISH FLOOR ABOVE FINISH ROOF ANNUAL FUEL UTILIZATION EFFICIENCY AIR HANDLING UNIT AIR PRESSURE DROP AVERAGE AVERAGE AVERAGE WATER TEMPERATURE	F FA FCU FD FDC FLA FLR FOB FOT FPI FPM FSD FT	FAHRENHEIT FREE AREA FAN COIL UNIT FIRE DAMPER FLEXIBLE DUCT CONNECTOR FULL LOAD AMPS FLOOR FLAT ON BOTTOM FLAT ON TOP FINS PER INCH FEET PER MINUTE FIRE SMOKE DAMPER FEET FIN-TUBE RADIATION
В	BOILER		
BDD	BACK DRAFT DAMPER	G	GAS
BHP	BRAKE HORSE POWER	GAL GC	GALLONS GENERAL CONTRACTOR
BMS BOD	BUILDING MANAGEMENT SYSTEM BOTTOM OF DUCT	GPM	GALLONS PER MINUTE
BOP	BOTTOM OF DOCT	OI IVI	GALLONG I EK MINOTE
BP	BOILER PUMP	HC	DUCT HEATING COIL
BSMT	BASEMENT	HD	HEAD
BTU	BRITISH THERMAL UNIT	HP	HORSEPOWER
		HVAC	HEATING, VENTILATING, AIR CONDITIONING
С	COMMON	HWP	HOT WATER PUMP
CFM	CUBIC FEET PER MINUTE	HX	HEAT EXCHANGER
CO	CLEAN OUT	HZ	HERTZ
COND	CONDENSER/CONDENSATE	IN.	INCH
CONV CP	CONVECTOR CIRCULATING PUMP	INT	INTERNAL
CT	COOLING TOWER	IW	INDIRECT WASTE
CUH	CABINET UNIT HEATER		
CV	CONTROL VALVE	KW	KILOWATT
CWP	CONDENSER WATER PUMP		
		LAT	LEAVING AIR TEMPERATURE
DB	DRY BULB	LBS	POUNDS
DC	DRY COOLER	LDB	LEAVING DRY BULB TEMPERATURE
DDC	DIRECT DIGITAL CONTROL	LF	LINEAR FEET
DIA	DIAMETER	LV LWB	LOUVER LEAVING WET BULB TEMPERATURE
DM DN	DAMPER MOTOR DOWN	LWT	LEAVING WATER TEMPERATURE
DN	DUCT SILENCER	LVVI	LEAVING WATER TEMI ERATORE
DSS	DUCTLESS SPLIT SYSTEM	MAU	MAKE-UP AIR UNIT
DWG	DRAWING	MAX	MAXIMUM
DX	DIRECT EXPANSION	MBH	THOUSAND BRITISH THERMAL UNITS
		MC	MECHANICAL CONTRACTOR
EA	EXHAUST AIR	MCA	MINIMUM CIRCUIT AMPS
EAT	ENTERING AIR TEMPERATURE	MD	MOTORIZED DAMPER
EC	ELECTRICAL CONTRACTOR	MFR	MANUFACTURER
EDB	ENTERING DRY BULB TEMPERATURE	MIN MOCP	MINIMUM MAXIMUM OVER CURRENT PROTECTION
EER EF	ENERGY EFFICIENCY RATIO	MOCP	MAXIMUM OVER CURRENT PROTECTION
EFF	EXHAUST FAN EFFICIENCY	NC	NORMALLY CLOSED
EQ	EQUIPMENT	NO	NORMALLY OPEN
ERV	ENERGY RECOVERY VENTILATOR		
ESP	EXTERNAL STATIC PRESSURE	OA	OUTSIDE AIR
ET	EXPANSION TANK	OAT	OUTSIDE AIR TEMPERATURE
ETR	EXISTING TO REMAIN	OC	ON CENTER
EWB	ENTERING WET BULB	OED	OPEN ENDED DUCT
EWT	ENTERING WATER TEMPERATURE	OEM	ORIGINAL EQUIPMENT MANUFACTURER
1 V	I MIN'I INIT'		

PC PLUMBING CONTRACTOR PD PRESSURE DROP PH PHASE PSI POUNDS PER SQUARE INCH QTY QUANTITY RA RETURN AIR RAD STEAM RADIATOR RCP REFLECTED CEILING PLAN RCP RADIANT CEILING PANEL RF RETURN FAN RFA RELIEF AIR RHC RE-HEAT COIL RPM REVOLUTIONS PER MINUTE RPZ REDUCED PRESSURE BACKFLOW PREVENTE RTU ROOF TOP UNIT RV PRESSURE RELIEF VALVE S/S STAINLESS STEEL SA SUPPLY AIR SD SMOKE DAMPER SF SUPPLY FAN SP STATIC PRESSURE SRV STATIONARY ROOFTOP VENTILATOR TA TRANSFER AIR TC TEMPERATURE CONTROL TYP TYPICAL UH UNIT HEATER V VOLT VAV VARIABLE AIR VOLUME VD VOLUME DAMPER VFD VARIABLE FREQUENCY DRIVE W WATTS WB WET BULB WC WATER COLUMN WG WATER PRESSURE DROP		
RA RETURN AIR RAD STEAM RADIATOR RCP REFLECTED CEILING PLAN RCP RADIANT CEILING PANEL RF RETURN FAN RFA RELIEF AIR RHC RE-HEAT COIL RPM REVOLUTIONS PER MINUTE RPZ REDUCED PRESSURE BACKFLOW PREVENTE RTU ROOF TOP UNIT RV PRESSURE RELIEF VALVE S/S STAINLESS STEEL SA SUPPLY AIR SD SMOKE DAMPER SF SUPPLY FAN SP STATIC PRESSURE SRV STATIONARY ROOFTOP VENTILATOR TA TRANSFER AIR TC TEMPERATURE CONTROL TYP TYPICAL UH UNIT HEATER V VOLT VAV VARIABLE AIR VOLUME VD VOLUME DAMPER VFD VARIABLE FREQUENCY DRIVE W WATTS WB WET BULB WC WATER COLUMN WG WATER GAGE	PD PH	PRESSURE DROP PHASE
RAD STEAM RADIATOR RCP REFLECTED CEILING PLAN RCP RADIANT CEILING PANEL RF RETURN FAN RFA RELIEF AIR RHC RE-HEAT COIL RPM REVOLUTIONS PER MINUTE RPZ REDUCED PRESSURE BACKFLOW PREVENTE RTU ROOF TOP UNIT RV PRESSURE RELIEF VALVE S/S STAINLESS STEEL SA SUPPLY AIR SD SMOKE DAMPER SF SUPPLY FAN SP STATIC PRESSURE SRV STATIONARY ROOFTOP VENTILATOR TA TRANSFER AIR TC TEMPERATURE CONTROL TYP TYPICAL UH UNIT HEATER V VOLT VAV VARIABLE AIR VOLUME VD VOLUME DAMPER VFD VARIABLE FREQUENCY DRIVE W WATTS WB WET BULB WC WATER COLUMN WG WATER GAGE	QTY	QUANTITY
SA SUPPLY AIR SD SMOKE DAMPER SF SUPPLY FAN SP STATIC PRESSURE SRV STATIONARY ROOFTOP VENTILATOR TA TRANSFER AIR TC TEMPERATURE CONTROL TYP TYPICAL UH UNIT HEATER V VOLT VAV VARIABLE AIR VOLUME VD VOLUME DAMPER VFD VARIABLE FREQUENCY DRIVE W WATTS WB WET BULB WC WATER COLUMN WG WATER GAGE	RAD RCP RCP RF RFA RHC RPM RPZ RTU	STEAM RADIATOR REFLECTED CEILING PLAN RADIANT CEILING PANEL RETURN FAN RELIEF AIR RE-HEAT COIL REVOLUTIONS PER MINUTE REDUCED PRESSURE BACKFLOW PREVENTE ROOF TOP UNIT
TC TEMPERATURE CONTROL TYP TYPICAL UH UNIT HEATER V VOLT VAV VARIABLE AIR VOLUME VD VOLUME DAMPER VFD VARIABLE FREQUENCY DRIVE W WATTS WB WET BULB WC WATER COLUMN WG WATER GAGE	SA SD SF SP	SUPPLY AIR SMOKE DAMPER SUPPLY FAN STATIC PRESSURE
V VOLT VAV VARIABLE AIR VOLUME VD VOLUME DAMPER VFD VARIABLE FREQUENCY DRIVE W WATTS WB WET BULB WC WATER COLUMN WG WATER GAGE	TC	TEMPERATURE CONTROL
VAV VARIABLE AIR VOLUME VD VOLUME DAMPER VFD VARIABLE FREQUENCY DRIVE W WATTS WB WET BULB WC WATER COLUMN WG WATER GAGE	UH	UNIT HEATER
WB WET BULB WC WATER COLUMN WG WATER GAGE	VAV VD	VARIABLE AIR VOLUME VOLUME DAMPER
	WB WC WG	WET BULB WATER COLUMN WATER GAGE

HVAC DUCTWORK SYMBOL LIST		HVAC PIPING SYMBOL LIST	
	DUCTWORK		- PIPING, NEW WORK - TYPE AS INDICATED
	EXISTING DUCTWORK TO REMAIN		- EXISTING PIPING TO REMAIN - TYPE AS INDICATED
}	EXISTING DUCTWORK TO BE REMOVED		EXISTING PIPING TO BE REMOVED - TYPE AS INDICATED
	EQUIPMENT	>	DIRECTION OF FLOW
	EXISTING EQUIPMENT TO REMAIN		BALL VALVE
	EXISTING EQUIPMENT TO BE REMOVED	ıΓ	BUTTERFLY VALVE
SA 20x12 ▶	DUCT TYPE, SIZE, & FLOW DIRECTION — FIRST FIGURE IS SIDE SHOWN	\bowtie	GATE VALVE
	TRANSITION, CONCENTRIC	\bowtie	TRIPLE DUTY VALVE
	TRANSITION, ECCENTRIC	∇	PLUG VALVE
	DUCT SECTION, POSITIVE PRESSURE		GLOBE VALVE
	DUCT SECTION, NEGATIVE PRESSURE		PRESSURE REDUCING VALVE
	POSITIVE PRESSURE DUCT THRU FLOOR OR ROOF	呂	TWO-WAY CONTROL VALVE
	NEGATIVE PRESSURE DUCT THRU FLOOR OR ROOF		THREE-WAY CONTROL VALVE
<u> </u>	INCLINED RISE (R) OR DROP (D), ARROW IN DIRECTION OF AIR FLOW	\sim	CHECK VALVE
SNR	STANDARD BRANCH CONNECTION, NO SPLITTER	l>, l	STRAINER
	STANDARD BRANCH CONNECTION, NO SPETTER	+4+	STRAINER WITH BLOWN DOWN VALVE AND CAP
	MITERED ELBOW WITH TURNING VANES	+++	DRAIN VALVE WITH CAP
	RADIUSED ELBOW	\otimes	FLOW BALANCER
		\bowtie	RELIEF (R) OR SAFETY (S) VALVE
b +4 b	AIR OUTLETS, CEILING (TYPE AS SPECIFIED/SCHEDULED)	•	STEAM TRAP
	AIR INLETS CELLING (TYPE AS SPECIFIED (SCHEDLILED)	Э	PIPE CAP
	AIR INLETS, CEILING (TYPE AS SPECIFIED/SCHEDULED)		CONNECTION, BOTTOM (GENERIC)
	AIR INLET/OUTLET, SIDE WALL, SQUARE OR RECTANGULAR (TYPE AS SPECIFIED/SCHEDULED)		CONNECTION, TOP (GENERIC)
⋛ ⋛ ⋛	AIR INLET/OUTLET, CEILING, LINEAR (TYPE AS SPECIFIED/SCHEDULED)	—	ELBOW UP (GENERIC)
* * * *		_	ELBOW DOWN (GENERIC)
TAD T	ACCESS DOOR, SIDE OR BOTTOM		TEE (GENERIC)
——————————————————————————————————————	ACOUSTICAL DUCT LINING, MAINTAIN INSIDE CLEAR DIMENSION AS NOTED IN PLAN		REDUCER, ECCENTRIC
	DUCT CAP	K	REDUCER, CONCENTRIC
	FLEXIBLE DUCT CONNECTION		FLANGE
			UNION
	POSITIVE PRESSURE DUCT DOWN	G	ALIGNMENT GUIDE
	NEGATIVE PRESSURE DUCT DOWN	\xrightarrow{A}	ANCHOR
	DUCT BREAK	P	PRESSURE-TEMPERATURE PORT
FDx	FIRE DAMPER, "X" DENOTES RATING 1=1.5HR, 3=3HR	ΛMV	MANUAL AIR VENT
■■■ SD	SMOKE DAMPER FIRE SMOKE DAMPER, "X" DENOTES RATING 1=1.5HR,	PAV	AUTOMATIC AIR VENT
FSDx	FIRE SMOKE DAMPER, X DENOTES RATING 1=1.5HR, 3=3HR	<u>D</u> R	DIRECTION OF PITCH, RISE OR DROP
MD	MOTORIZED AIR DAMPER, ELECTRIC OR PNEUMATIC	Ф	THERMOMETER
VD	MANUAL VOLUME DAMPER	∑	PRESSURE GAUGE
	UNDERCUT DOOR	_ <u>EJ</u>	EXPANSION JOINT
	DOOR LOUVER	EC_	EXPANSION COMPENSATOR
NECK CFM-A	RETURN/EXHAUST, GRILLE OR REGISTER IDENTIFICATION	EL	EXPANSION LOOP
NECK CFM-1	SUPPLY, DIFFUSER/GRILLE/REGISTER IDENTIFICATION	- 	FLEXIBLE CONNECTOR
HVAC REFERENCE SYMBOL LIST		(PIPE BREAK
Θ	CONNECT NEW TO EXISTING	<u>CODES</u>	LIMBING CODE (2045) INOLLIBRIO NIVO AMENDARNITO (2427) (2012 TTI
X	TERMINATION POINT OF DEMOLITION	INTERNATIONAL FU	LUMBING CODE (2015) INCLUDING NYS AMENDMENTS (2107) (2019 PENI JEL GAS CODE (2015) INCLUDING NYS AMENDMENTS (2107) (2019 PENI TOUANNO NO CORE (2015) INCLUDING NYS AMENDMENTS (2107) (2019 PENI
	•		ECHANICAL CODE (2015) INCLUDING NYS AMENDMENTS (2107) (2019 PE

BACKFLOW PREVENTION

STRUCTURES

ELECTRICAL CODE AND NFPA 72

NEW YORK STATE HEALTH DEPARTMENT CROSS CONNECTION CONTROL MANUAL FOR DOMESTIC WATER

NEW YORK STATE HEALTH DEPARTMENT PART 14 - SUBPART 14.1 FOOD SERVICE ESTABLISHMENTS

ERIE COUNTY HEALTH DEPARTMENT CODES AND THEIR REQUIREMENTS FOR FOOD SERVING KITCHENS

CITY OF BUFFALO PLUMBING CODE REQUIREMENTS AS PER THE PLUMBING INSPECTION DEPARTMENT

BUFFALO SEWER AUTHORITY - (BSA) - REQUIREMENTS FOR SANITARY SEWER EXTENSIONS TO SITE

CITY OF BUFFALO DIVISION OF WATER REQUIREMENTS FOR WATER MAINS AND BACKFLOW PREVENTION

SECTION. TOP CHARACTER INDICATES SECTION NUMBER, BOTTOM CHARACTER INDICATES DRAWING ON WHICH

SECTION APPEARS


DEMOLITION KEYED NOTE

REVISION KEYED NOTE

KEYED NOTE

X-X



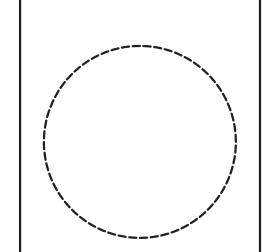

Drawn By: MPC
Checked By: MJS
Project Manager: RCP

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COVER DRAWING

SWBR Project Number 18630.00

City of Buffalo Parks & Buffalo Public School Facilities Survey & Design Development Client Address


M-001

COVER SHEET


4.1.2019 Design Development

KEYED NOTES (#)

- PROVIDE ROOF MOUNTED EXHAUST FAN. 310 CFM @ 0.25" WC E.S.P., PITCHED ROOF CURB, 120V LOW LEAKAGE DAMPER, DIRECT DRIVE EC MOTOR WITH REMOTE POTENTIOMETER FOR BALANCING. FAN SHALL OPERATE WHEN OCCUPANCY SENSOR IN EITHER BATHROOM SIGNALS.
- 2. REMOTE POTENTIOMETER FOR FAN BALANCING. PROVIDE LOCKING COVER.
- 3. PROVIDE 1.5KW ELECTRIC WALL HEATER. SURFACE MOUNTED, HEAVY GAUGE ENCLOSURE, TAMPERPROOF THERMOSTAT WITH POSITIVE OFF.
- 4. PROVIDE ROOF MOUNTED EXHAUST FAN. 200 CFM @ 0.1" WC E.S.P., PITCHED ROOF CURB, 120V LOW LEAKAGE DAMPER, DIRECT DRIVE EC MOTOR WITH REMOTE POTENTIOMETER FOR BALANCING. FAN SHALL OPERATE VIA LOCAL SWITCH

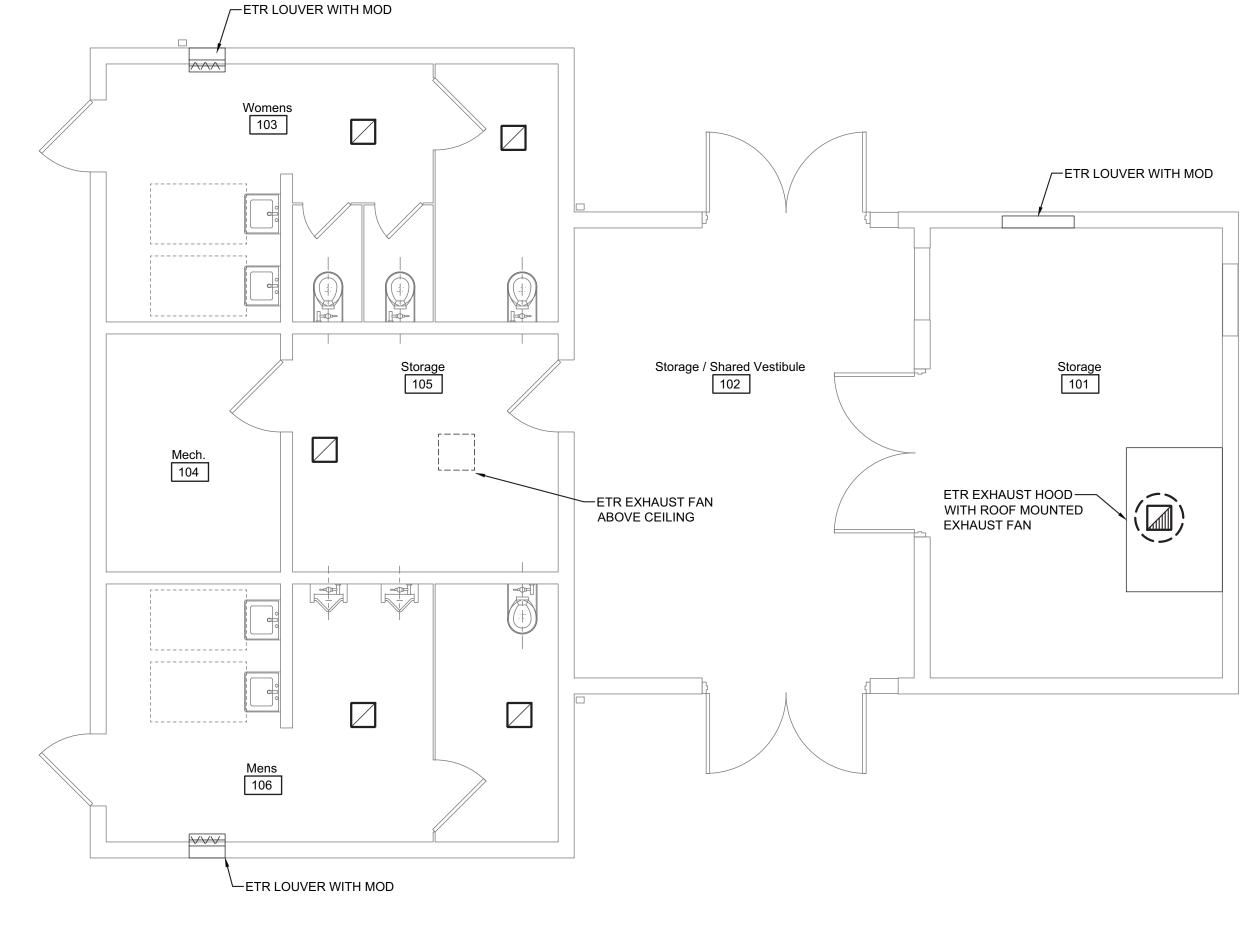




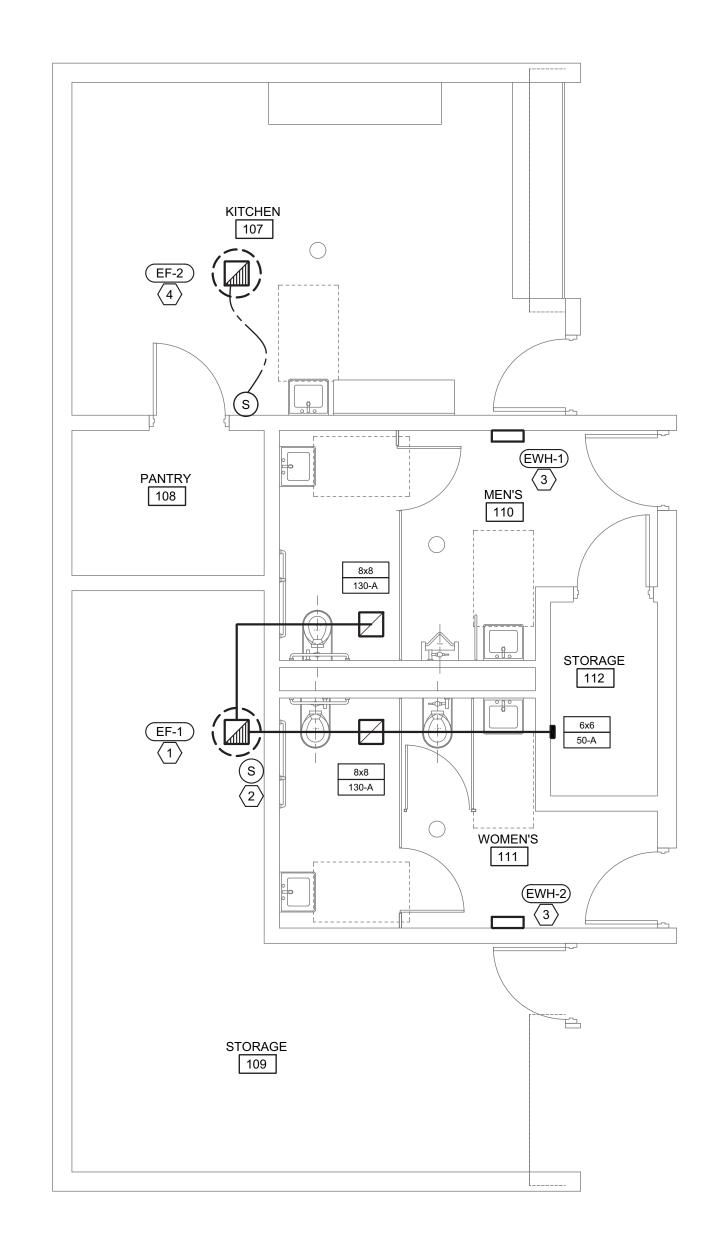

PROTOTYPE BUILDING MECHANICAL PLAN

1/4" = 1'-0"



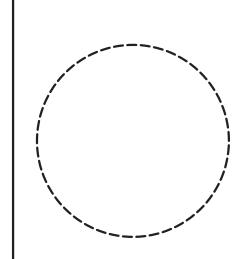

Drawn By:	BMW
Checked By:	JEM
Proiect Manager:	RCP

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Revisions


McCarthy Park
SWBR Project Number 18630.00


City of Buffalo Parks & Buffalo
Public School Facilities Survey
& Design Development
Client Address

M-101

FIRST FLOOR
MECHANICAL PLAN

4.1.2019Design Development

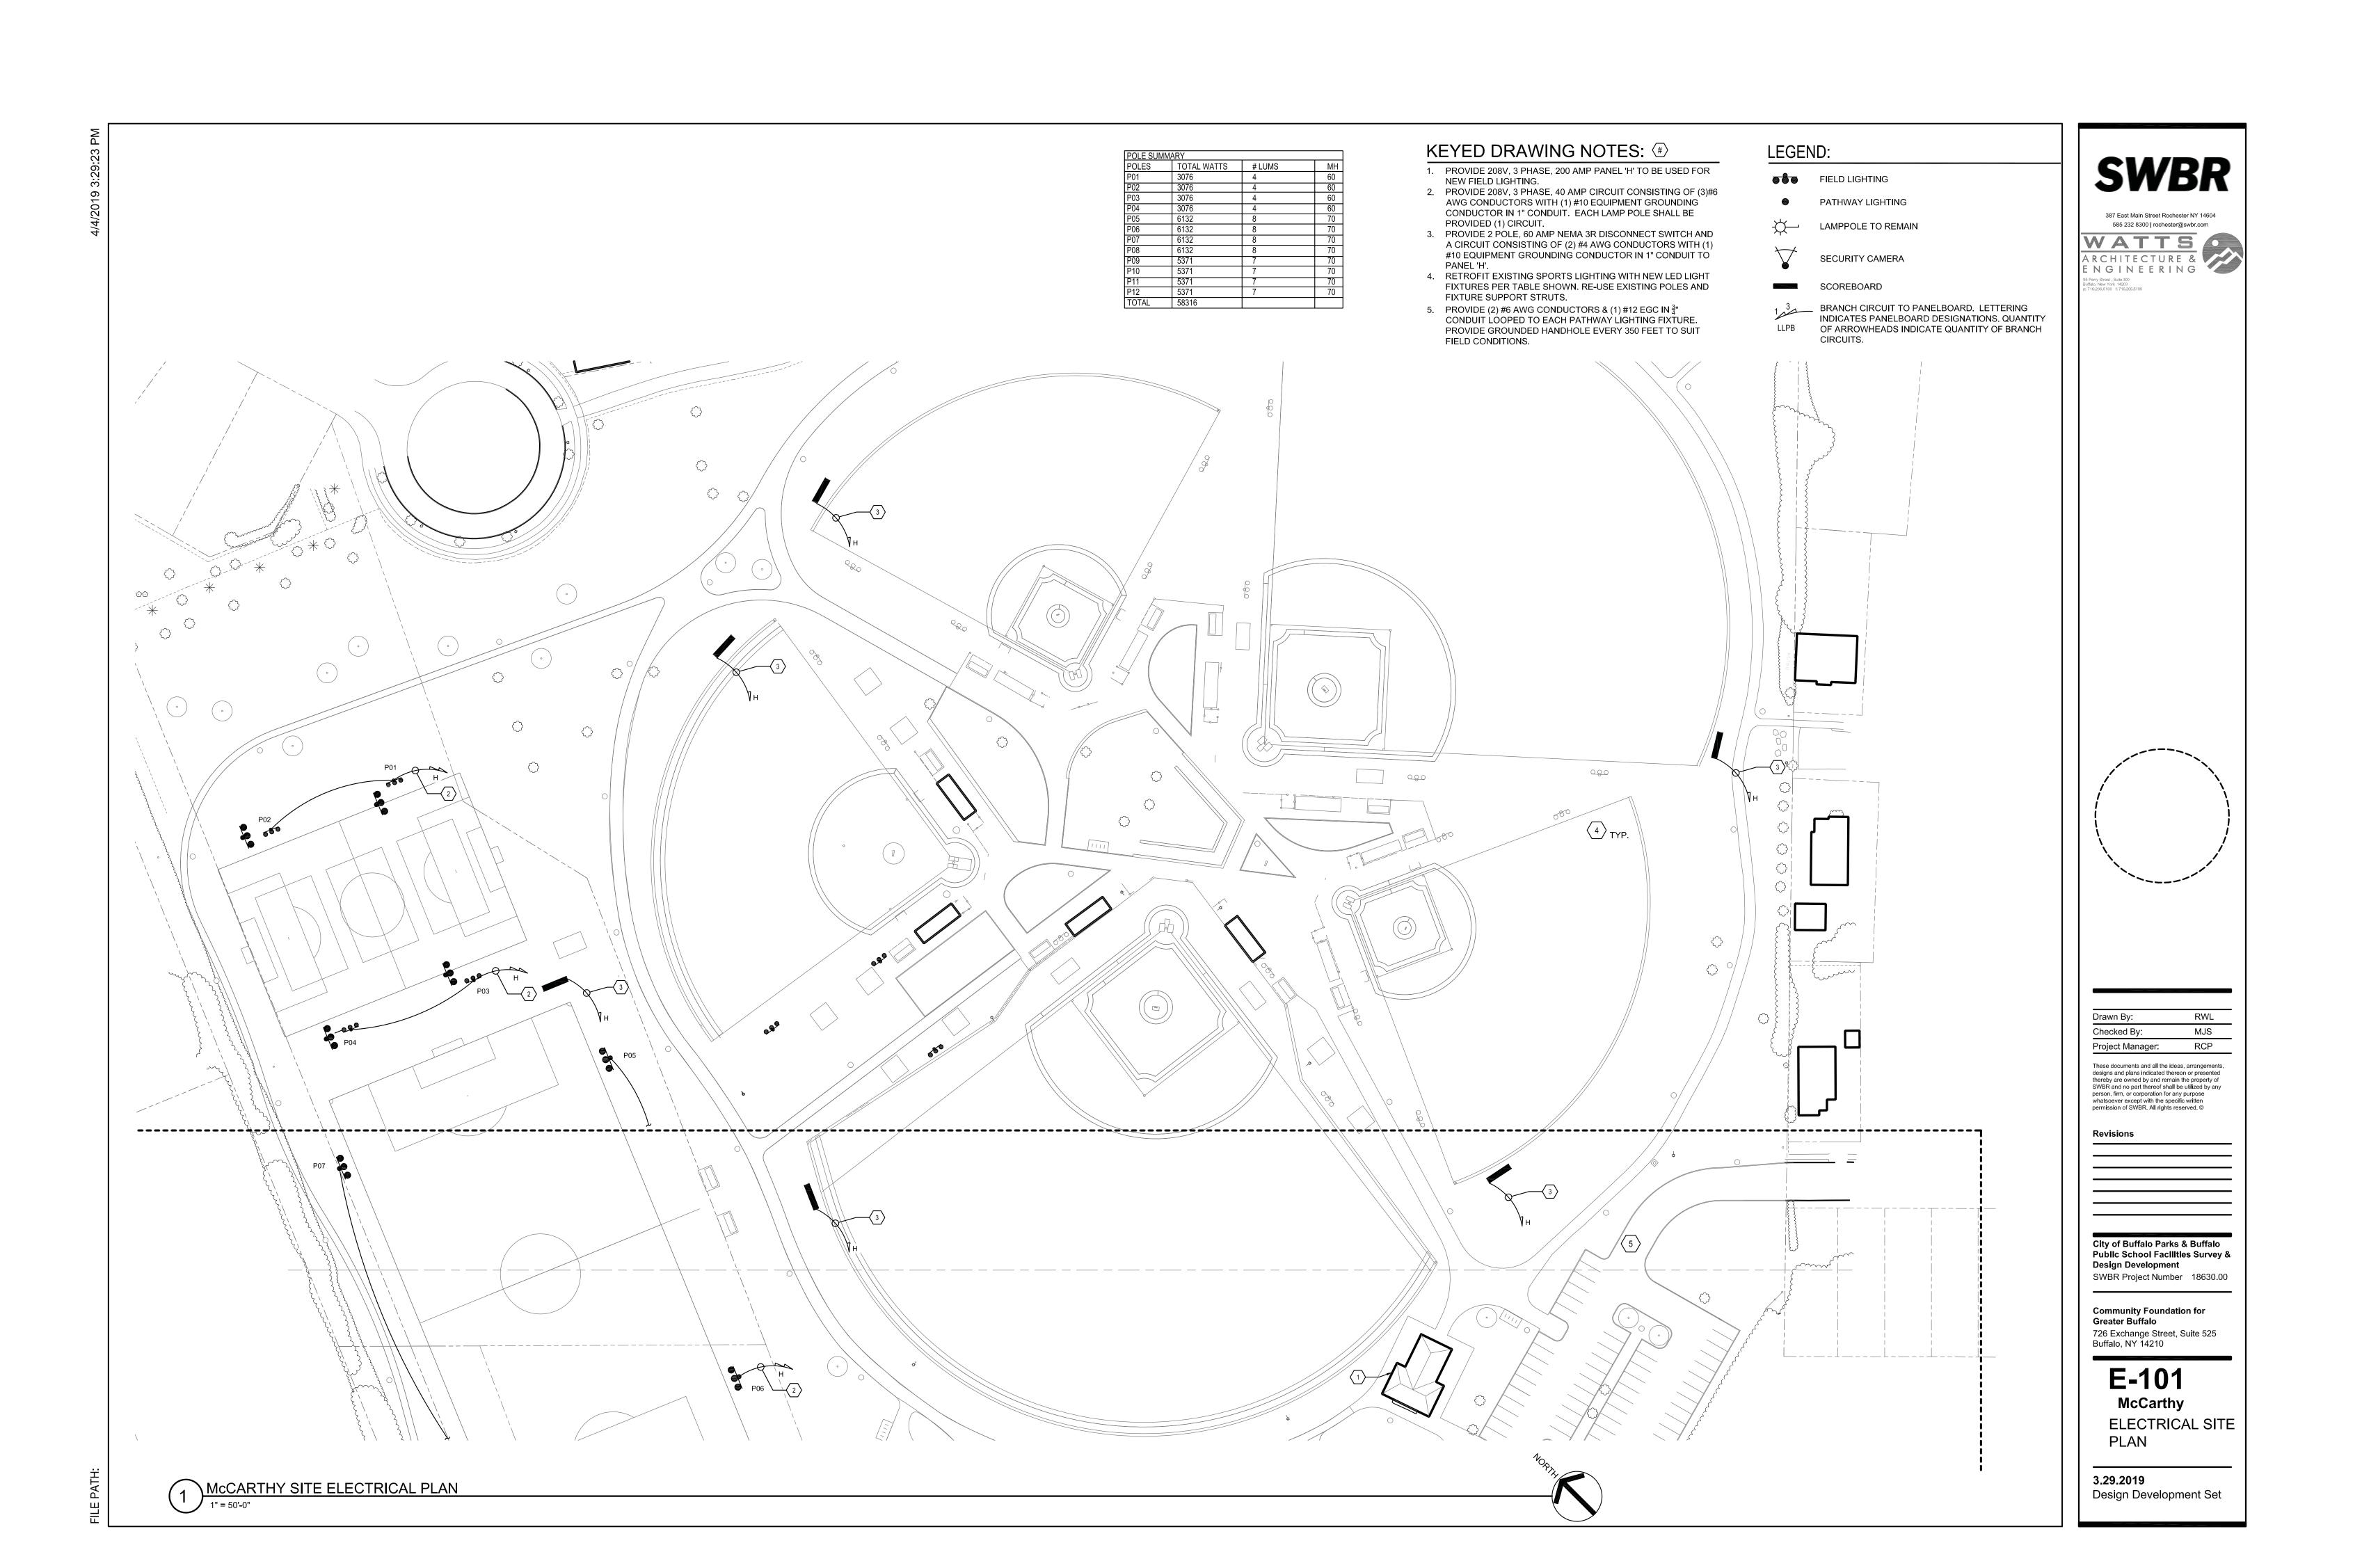

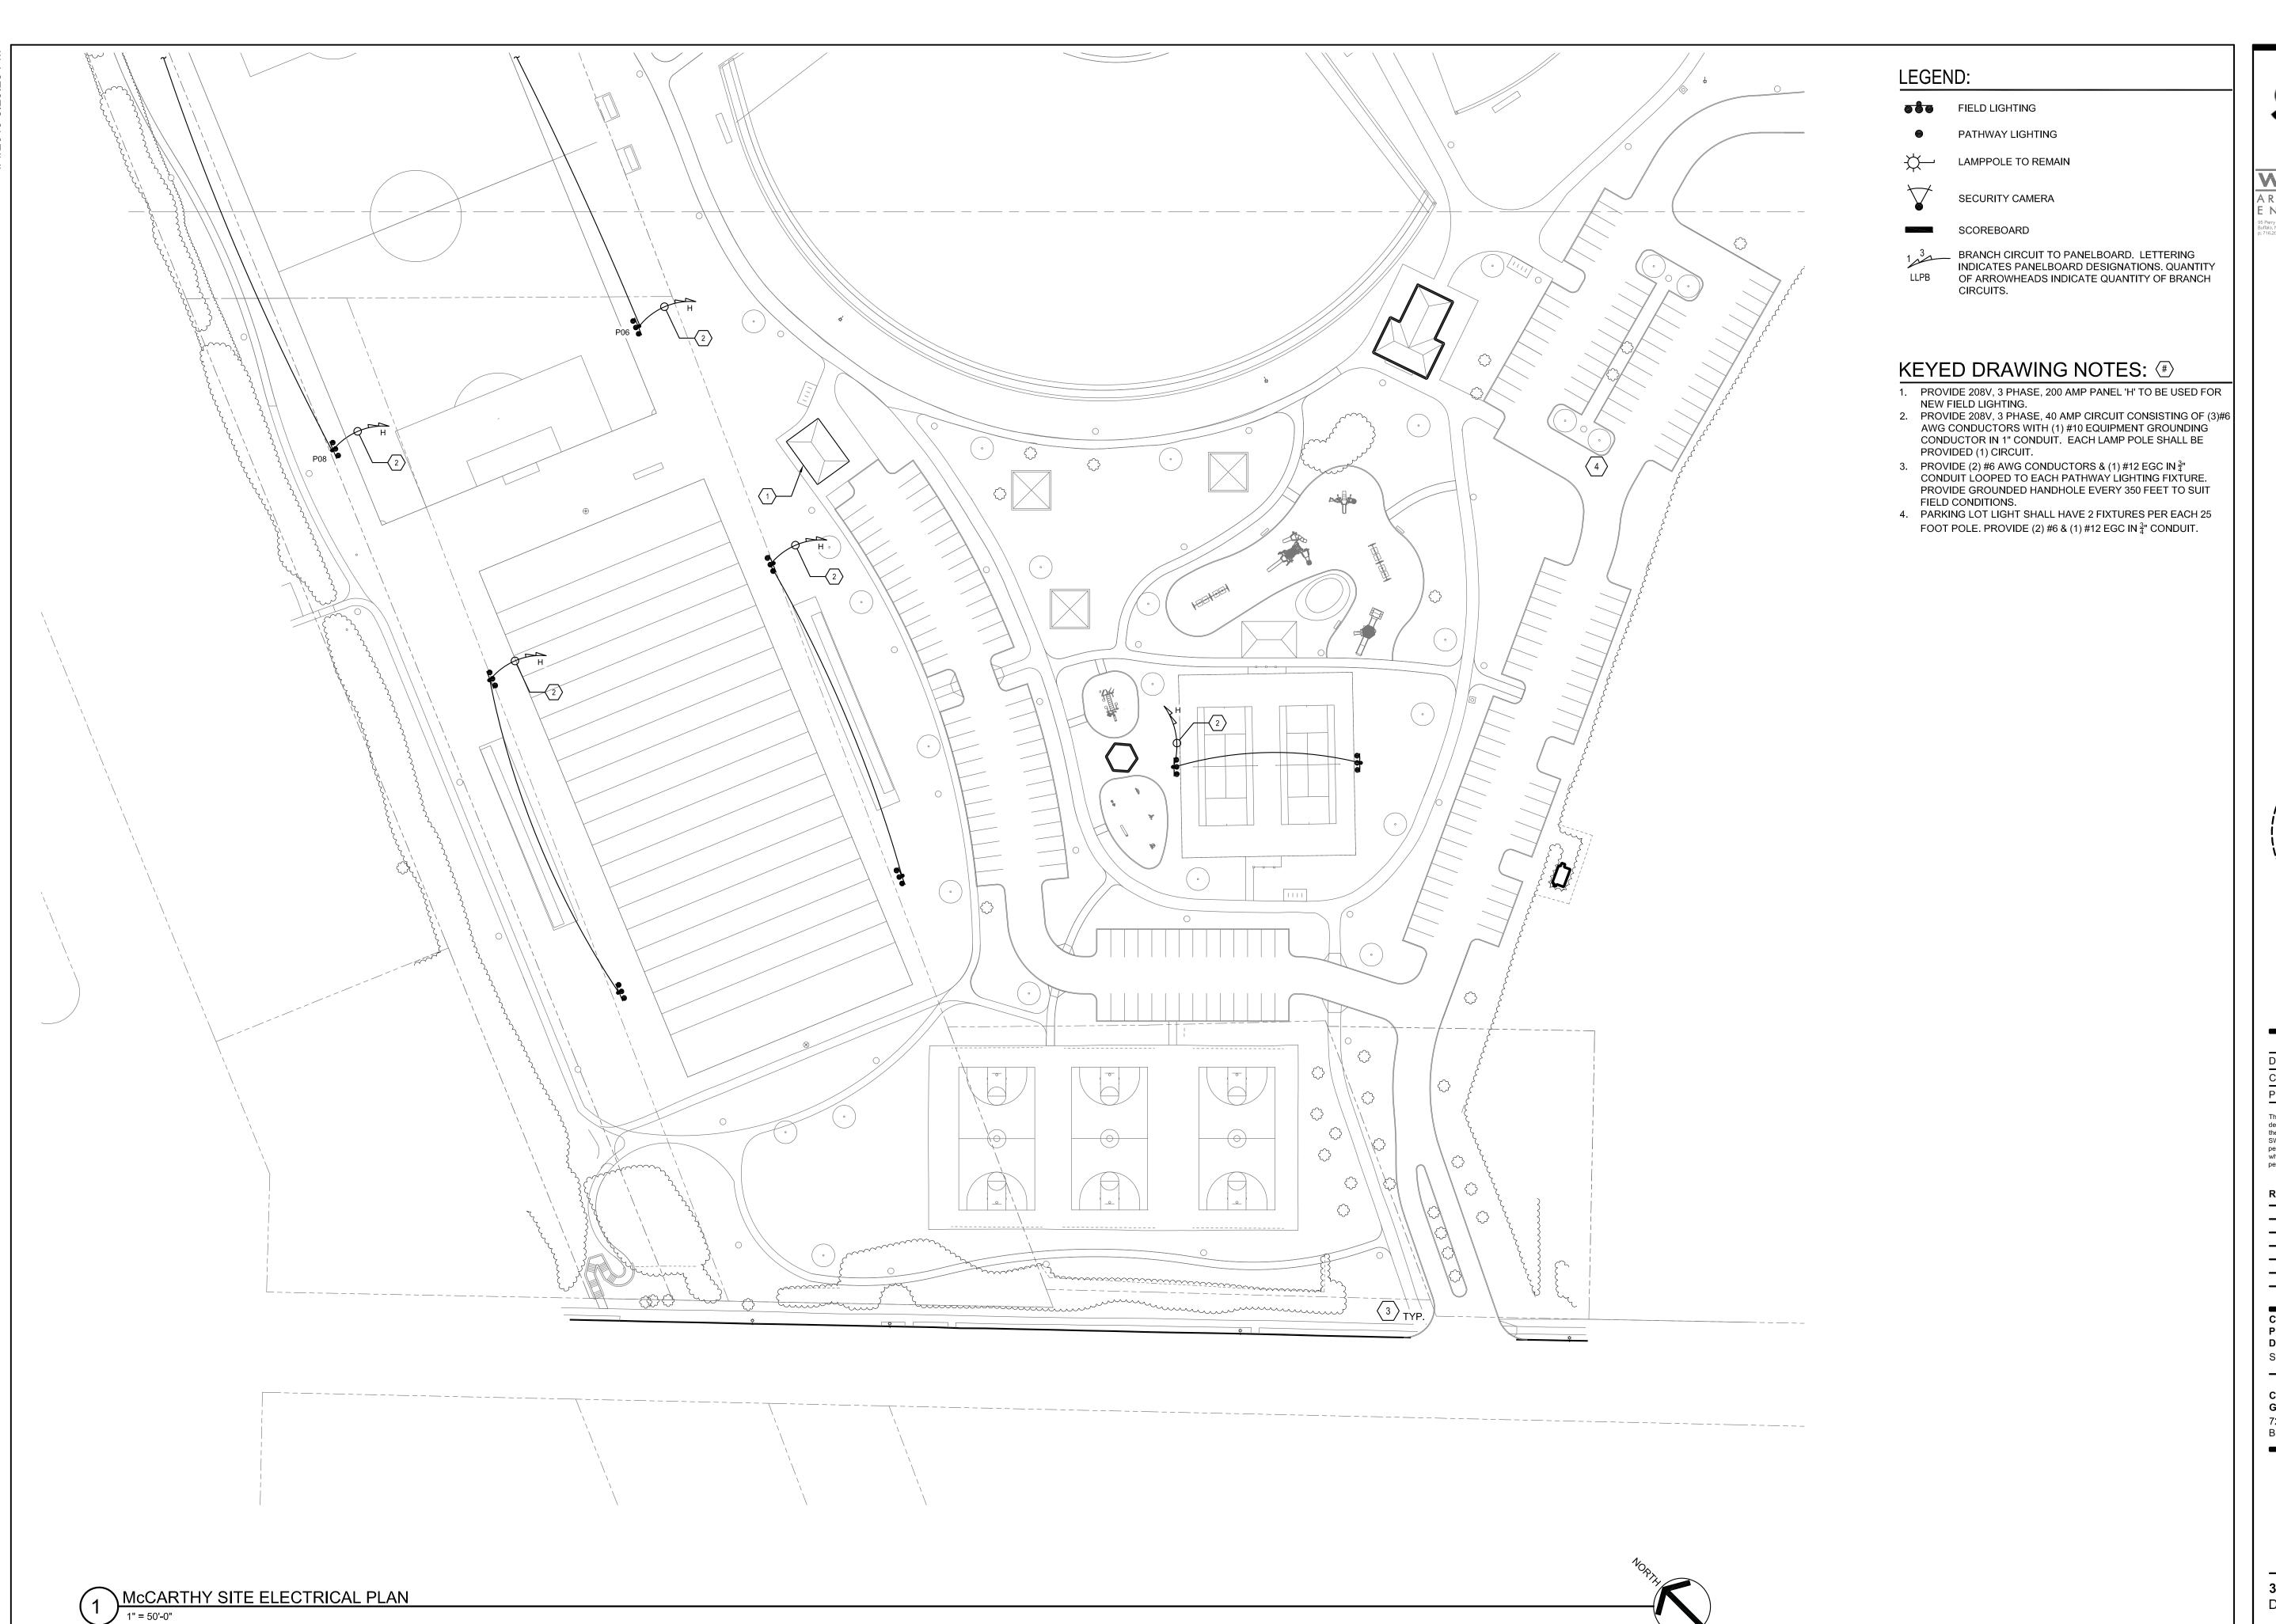

387 East Main Street Rochester NY 14604
585 232 8300 | rochester@swbr.com

387 East Main Street Rochester NY 14604
585 232 8300 | rochester@swbr.com

ARCHITECTURE &
ENGINEERING

Drawn By: MPRWL
Checked By: MJS
Project Manager: RCP

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Revisions

City of Buffalo Parks & Buffalo Public School Facilities Survey & Design Development SWBR Project Number 18630.00

Community Foundation for Greater Buffalo 726 Exchange Street, Suite 525 Buffalo, NY 14210

E-102
McCarthy

ELECTRICAL SITE PLAN