















Masten Park












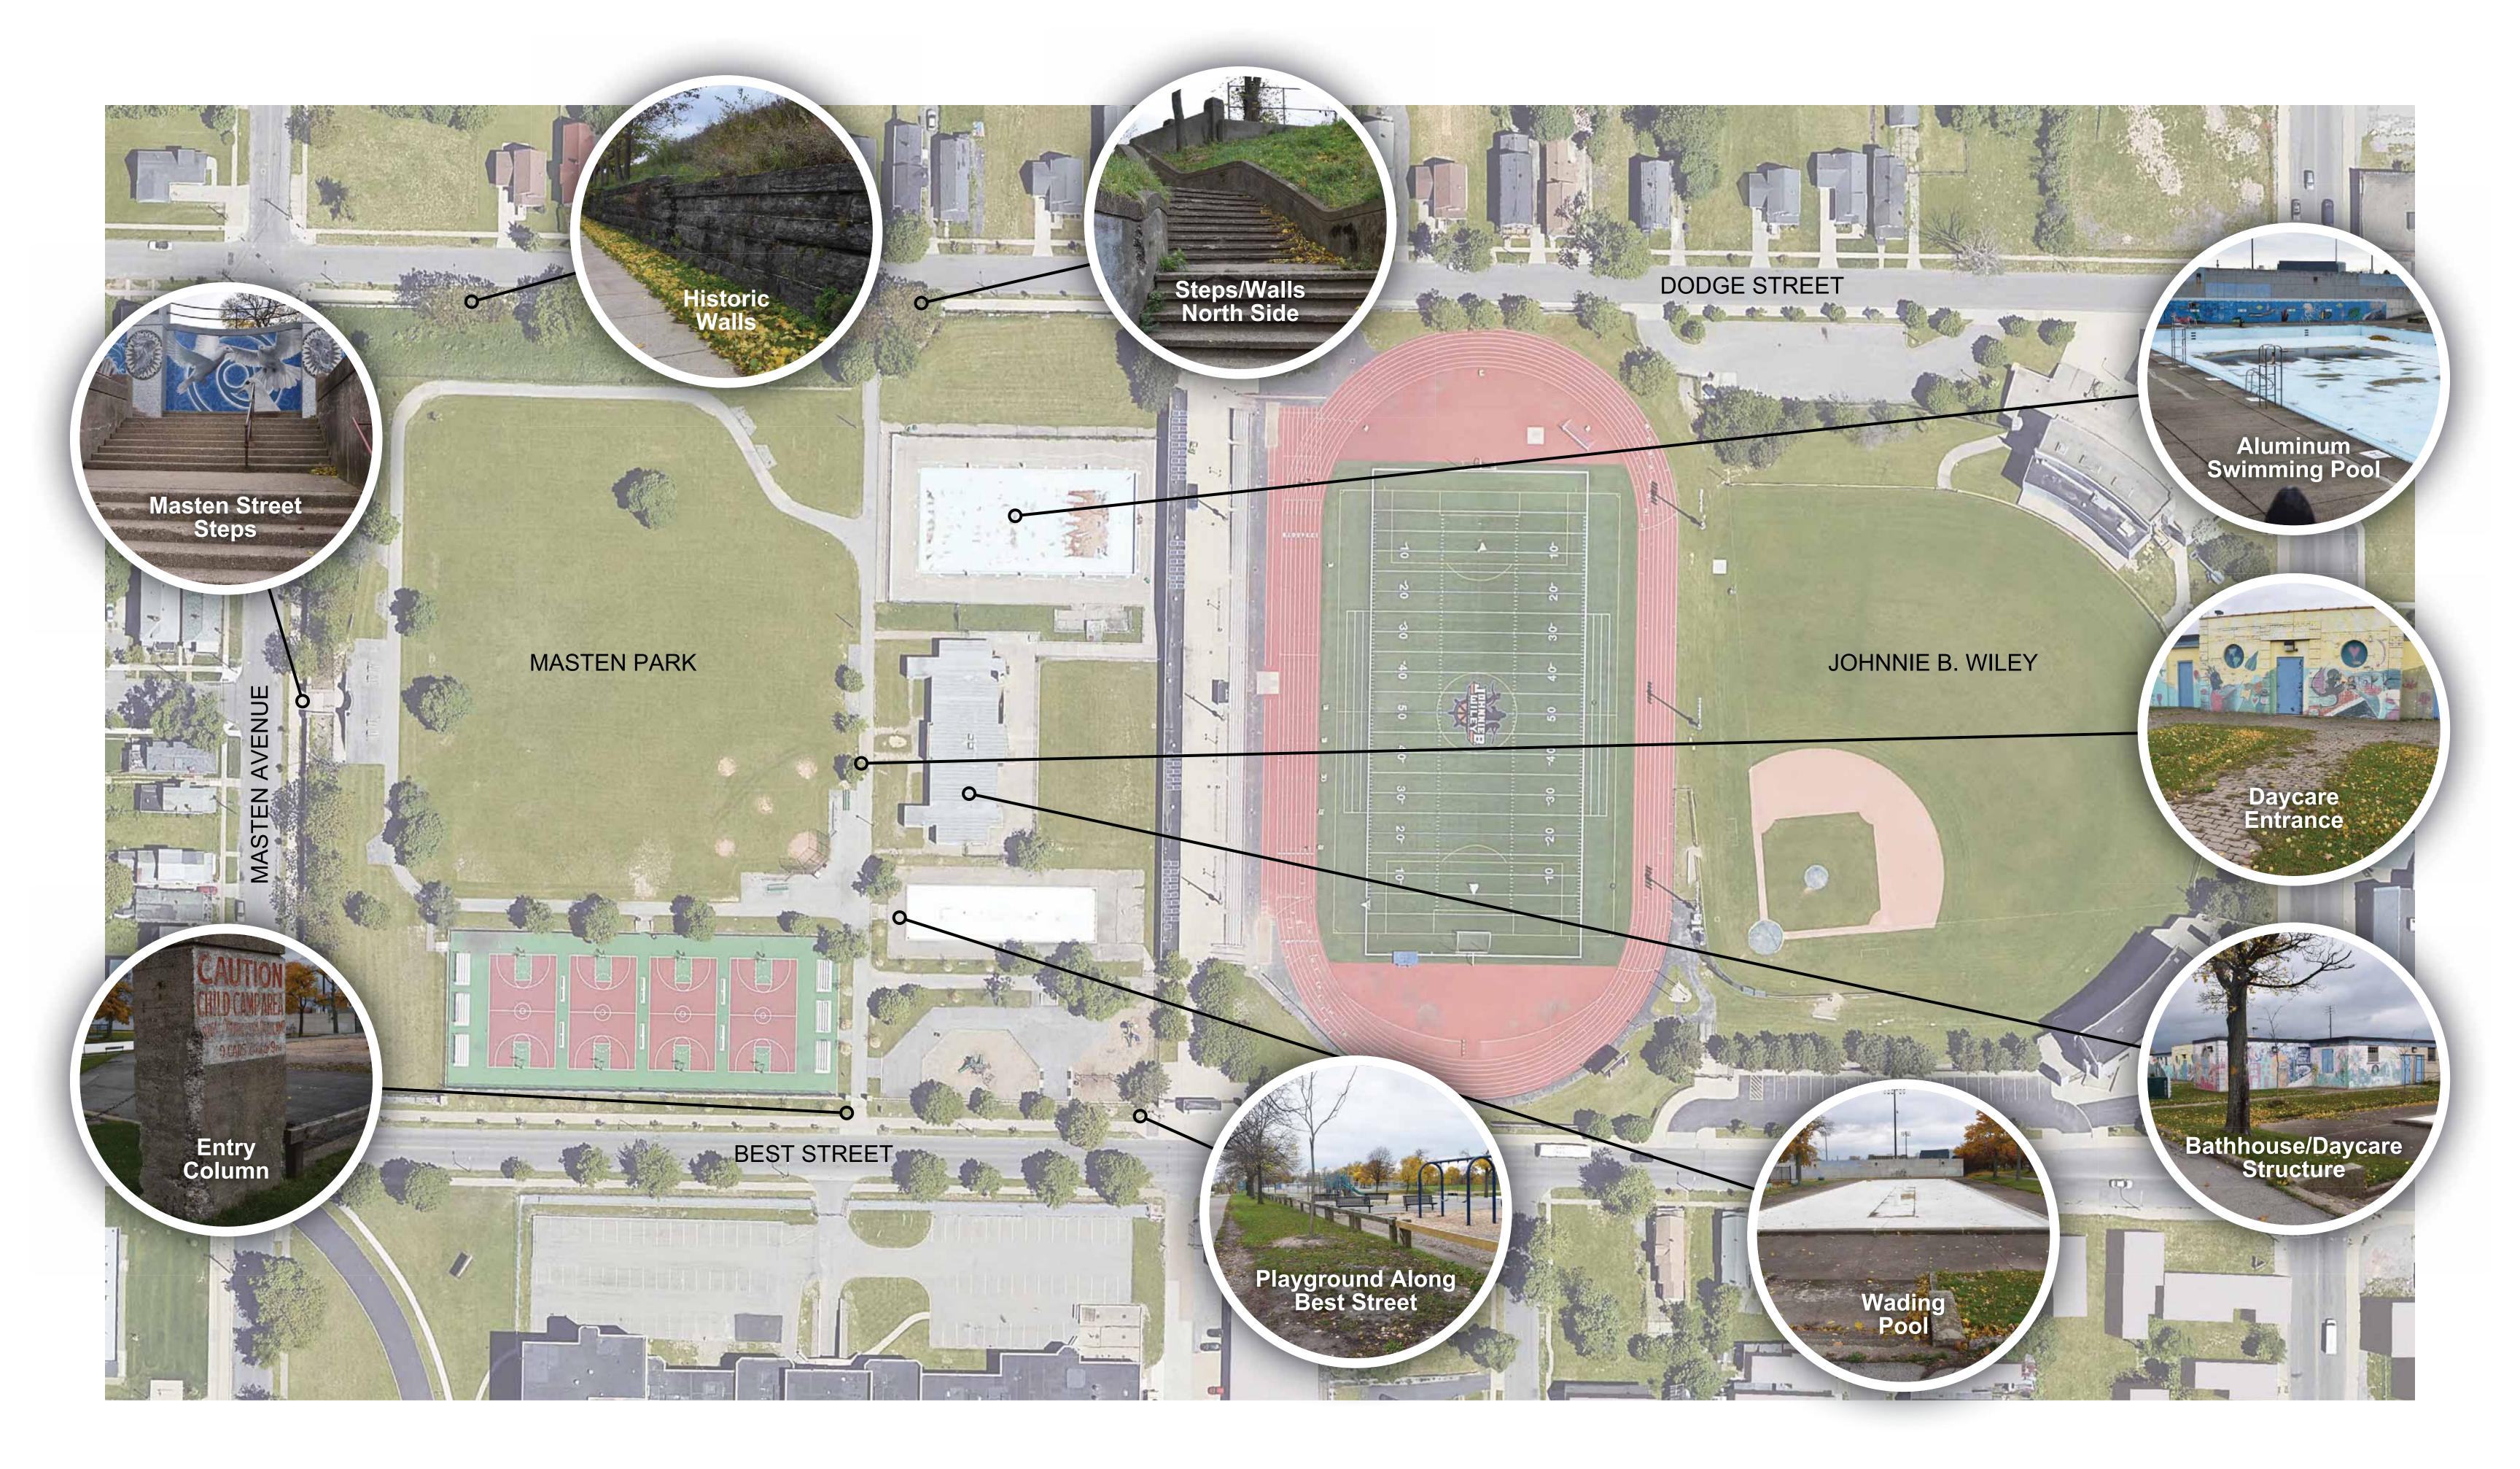

JBW / Masten Park












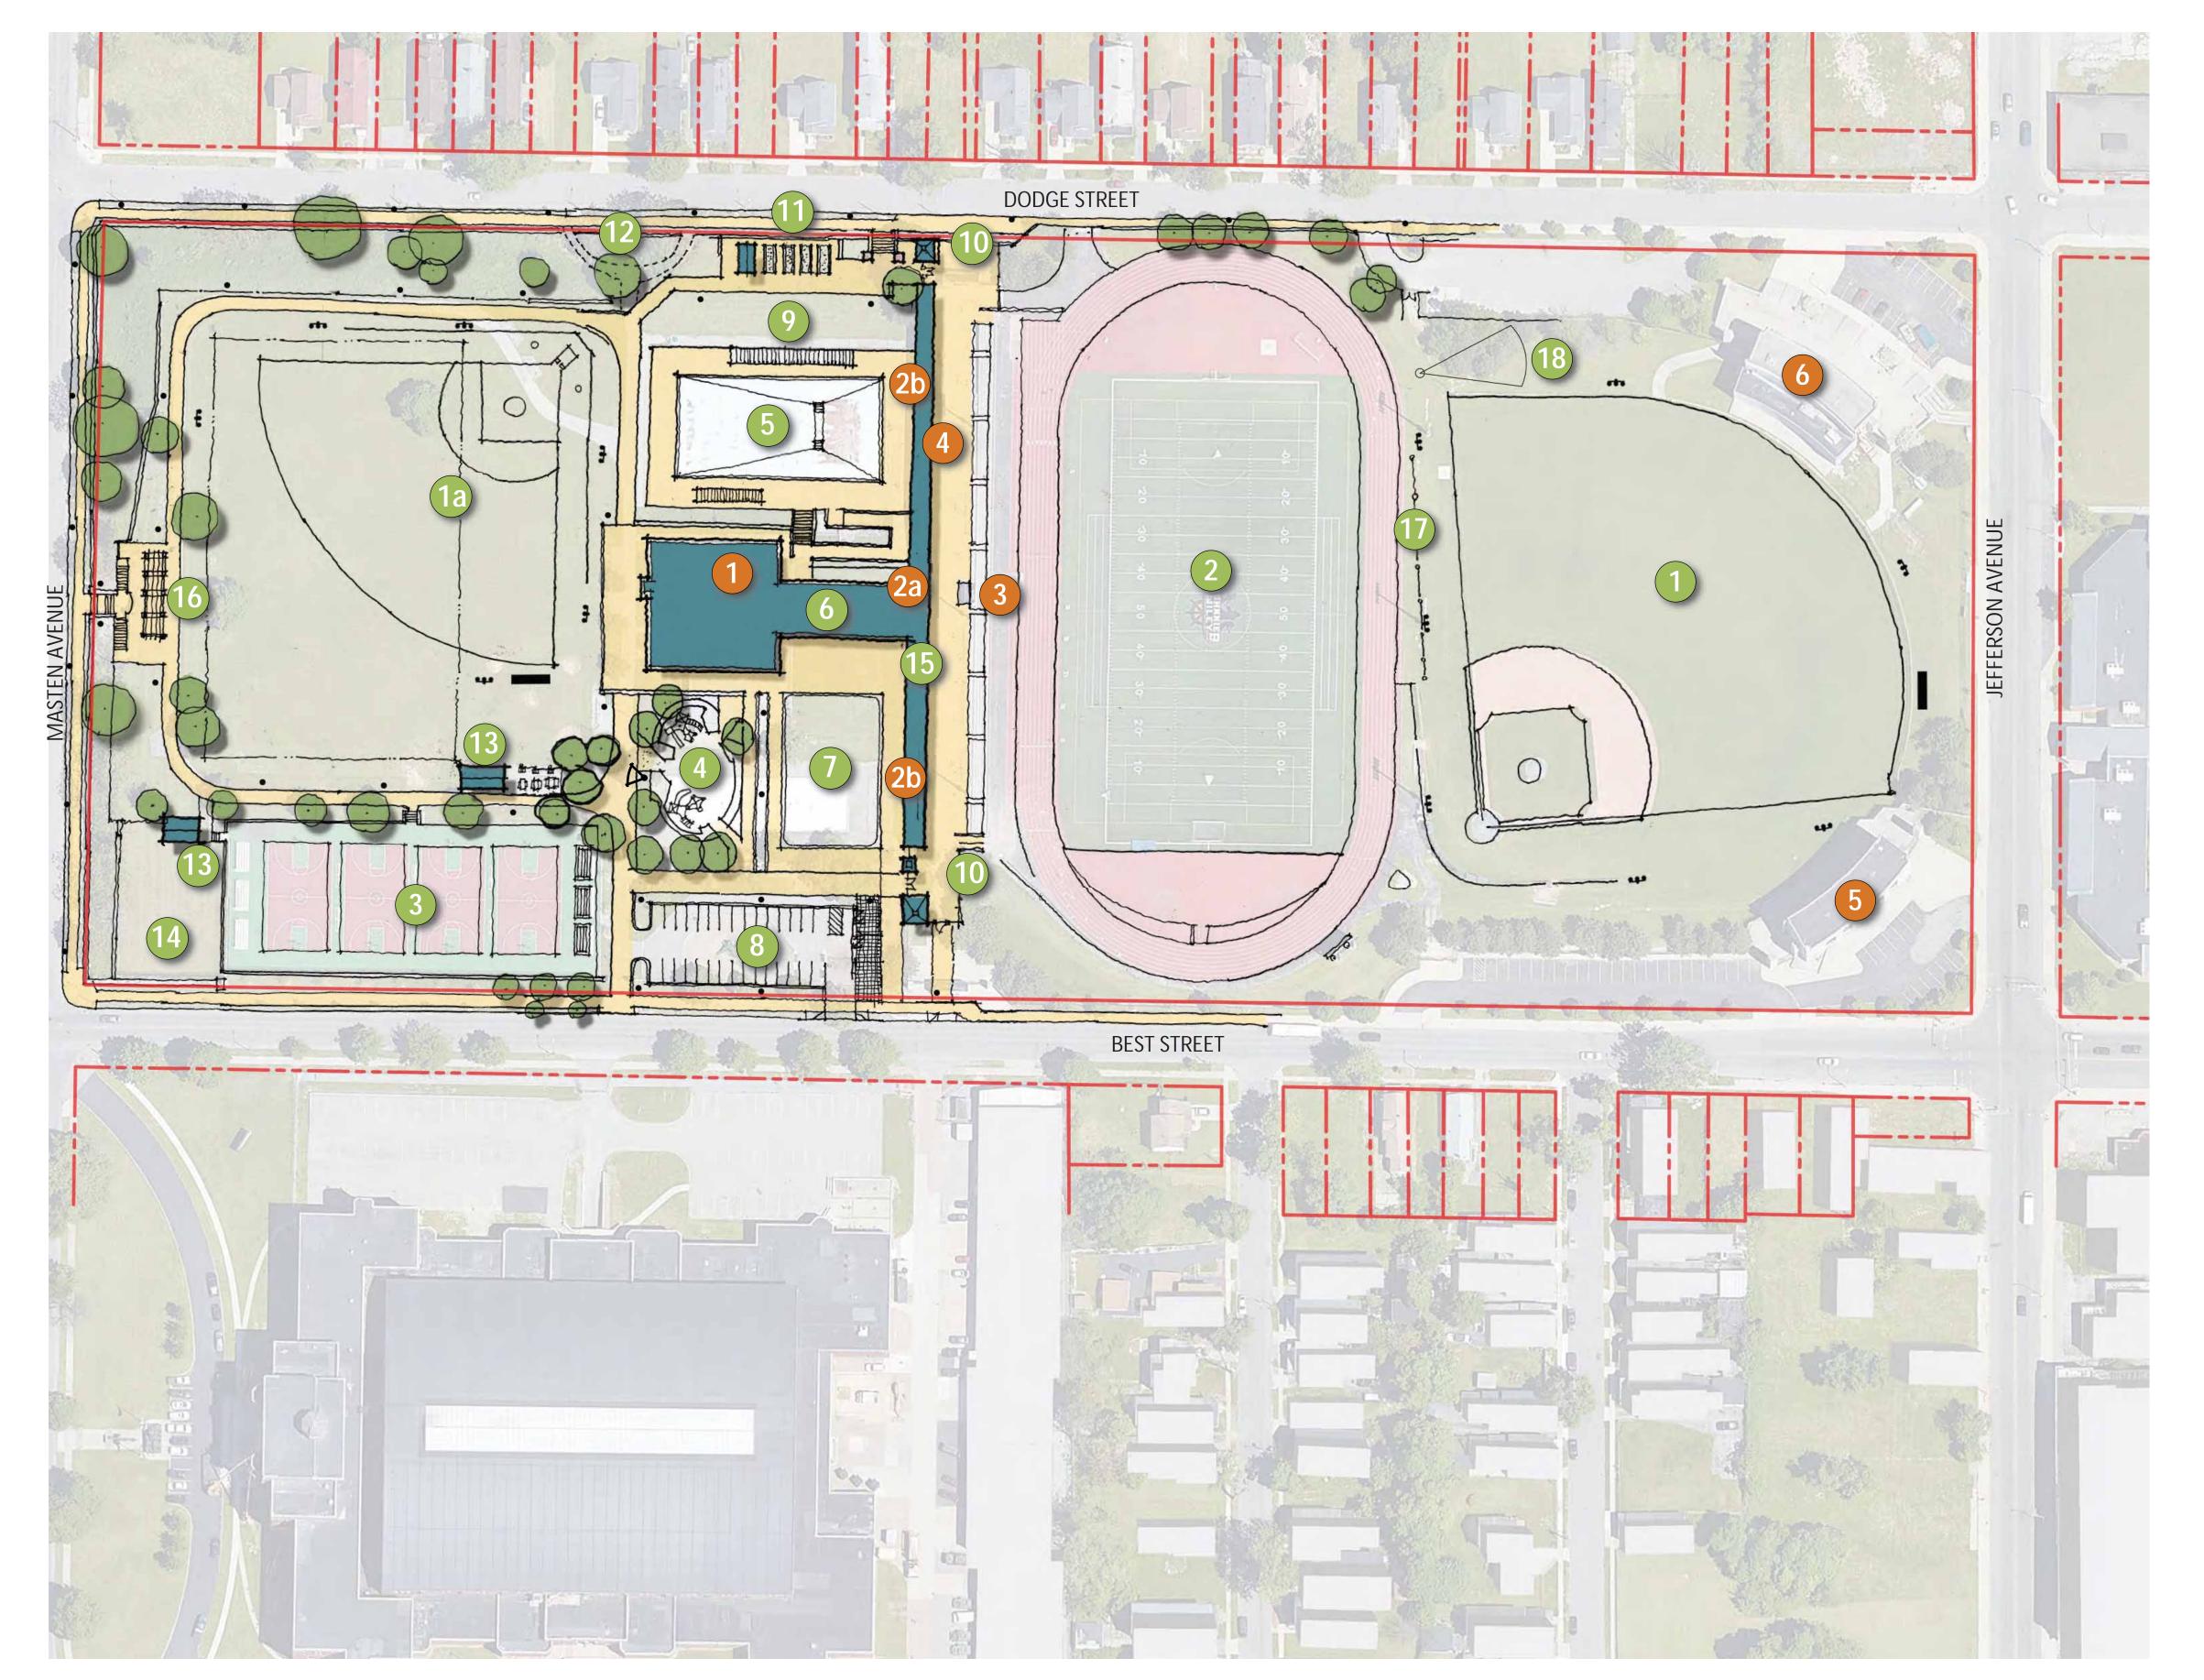

SITE LEGEND:

- Baseball Field (Synthetic Turf)
- 9 Open Space
- Softball Field
- New Entrance Gates
- Existing Multi-purpose Field (New Synthetic Turf)
- Community Gardens
- Existing Basketball Courts
- Demolish Existing Stairs
- 4 Playground
- Shelter

 ADA Compliant Fitness
- 6 New Building
- Locker Room Expansion
- 7 Splash Pad
- Trellis Structure
- High Screen
- Pathway Lighting
- 8) Shot-put
- ••• Field Lighting
- Scoreboard
- Security Camera
- Demolish entire building.
- Complete renovation of concession stand. Possible expansion into locker rooms.
- Renovate to provide: new entry to expanded locker room, referee locker room, training room
- Renovate locker room into public toilets. Womens: 8 WC, 8 LAV. Mens: 5 WC, 5 URINALS, 8 LAV
- Replace press box. Capacity for 10 people
- Repair damaged facade, paint entire facade, and replace roof.
- Restore ticket booth to original condition. Renovate 1st Floor to be a museum for old rock pile. Renovate 2nd & 3rd Floors to be boxing training area. Include elevator, locker rooms, toilet rooms, reconfigure stair tower replacement.
- Renovate 1st & 2nd Floors. Add technology upgrades throughout entire building. Roof replacement.













DRAWING LIST - JBW/MASTEN PARK

General

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L-000 Existing Conditions/ Survey (West)
L-001 Existing Conditions/ Survey (East)

L-002 Demolition Plan L-101 Site Layout Plan (West) L-102 Site Layout Plan (East)

Civil

C-101 Grading, Drainage & Utility (West) PlanC-102 Grading, Drainage & Utility (East) Plan

Architectural

A-101 Service Building - First Floor Demolition Plan A-102 Service Building - First Key Plan & Part C A-103 Service Building - First Floor Plan - Part B

A-104 Service Building - Elevations - North & East
A-105 Service Building - Elevations - South & West
A-106 North Tower - Demolition Plan and New Work Plan

A-106 North Tower - Demolition Plan and New Work Plan A-107 South Tower - Demolition Plan and New Work Plan Plumbing

PD-101 Plumbing First Floor Plan Area B-Removal P-101 Plumbing First Floor Plan Area C & D

P-102 Plumbing First Floor Plan Area B **Electrical**

E-101 Electrical Site Plan E-102 Electrical Site Plan

CMU SERIES PARTITIONS

C6 5 5/8" 6" CMU WITH HORIZONTAL REINFORCING AT 16" O.C. (VERT.)

C8 7 5/8" 8" CMU WITH HORIZONTAL REINFORCING AT 16" O.C. (VERT.)


C12 11 5/8" 12" CMU WITH HORIZONTAL REINFORCING AT 16" O.C. (VERT.)

Drawing symbols

View title Detail no.	Exterior elevation		001) OR (100) A	Door numbers
Title	Elevation no	D. —X	001	Window type
SCALE: X"=1'-0"	Drawing no.	A-XXX	101	Room number
Building / wall section cut	Interior elevations	1	1	Revision
Detail no. Viewing direction	Elevation no.—	2 (A-XXX) 4	C12 OR	C12 Partition type
A-XXX Drawing no.	Drawing no	03	1	Plan key note
Detail section cut	Structural grid	2	1	Demolition key note
Detail no. Viewing direction	_	A	1/ 8'-0" AFF	Ceiling type and heigh
DRAWING NO.		В		
Detail - blow up	Accessibility	V/HAU		
Detail no.	Si	Visual / hearing accommodation unit		
Drawing no.	Accessible unit			


Material symbols

	Undisturbed earth		Steel - large scale (Other metals as noted)	Batt insulation
	Gravel or crushed stone	I	Steel - small scale (Other metals as noted)	Rigid insulation
	Stone	\boxtimes	Wood framing (continuous)	Wood blocking (intermittent)
4 4 4	Concrete		Finish wood	
	Concrete masonry unit		Plywood	
	Brick		Gypsum, sand, mortar	

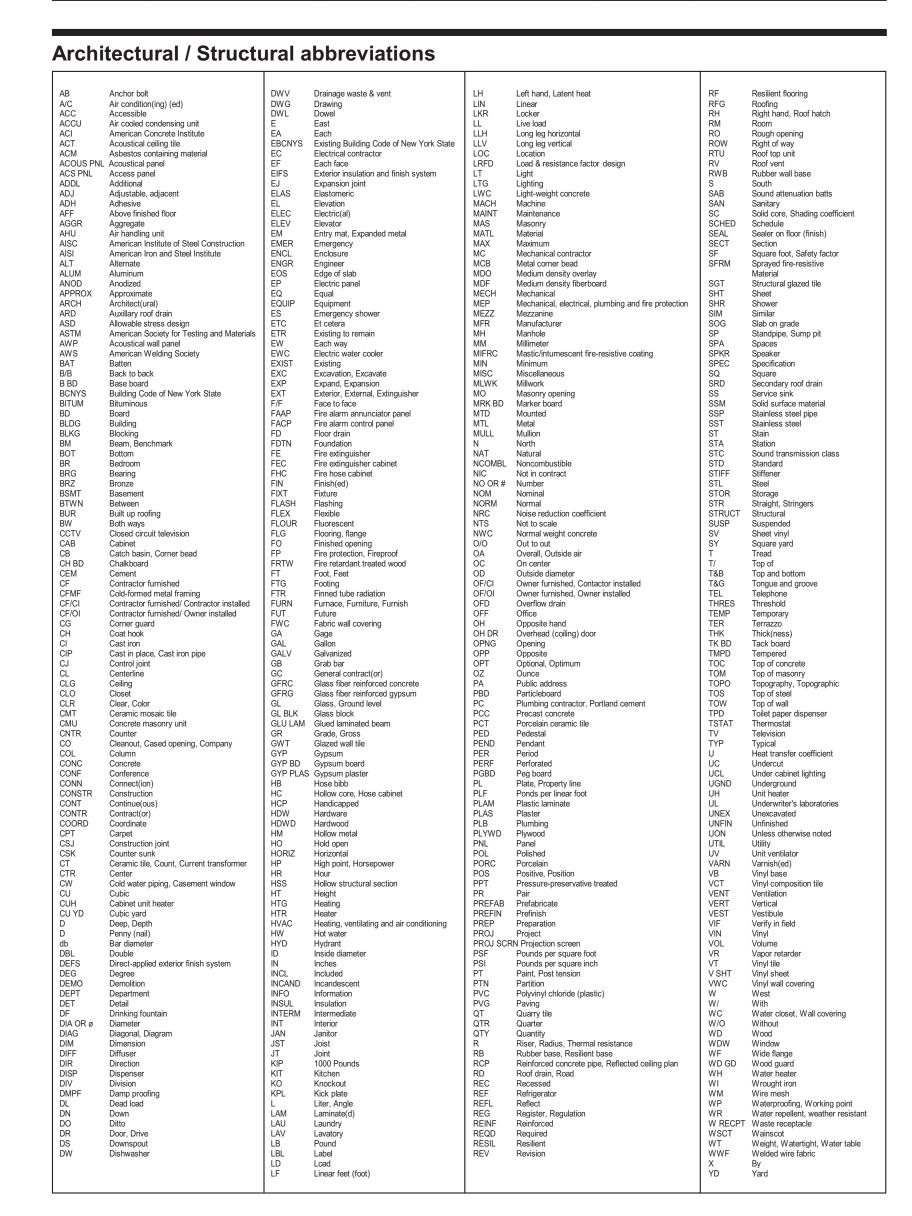



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Drawn By: Author
Checked By: Checker
Project Manager: DP
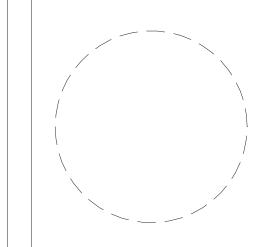
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Revisions


City of Buffalo Parks & Buffalo Public School Facilities Survey & Design Development

SWBR Project Number 18630.00

Community Foundation for Greater Buffalo 726 Exhange Street, Suite 52 Buffalo, NY 14210

G-001

General Notes, Legends & Drawing List

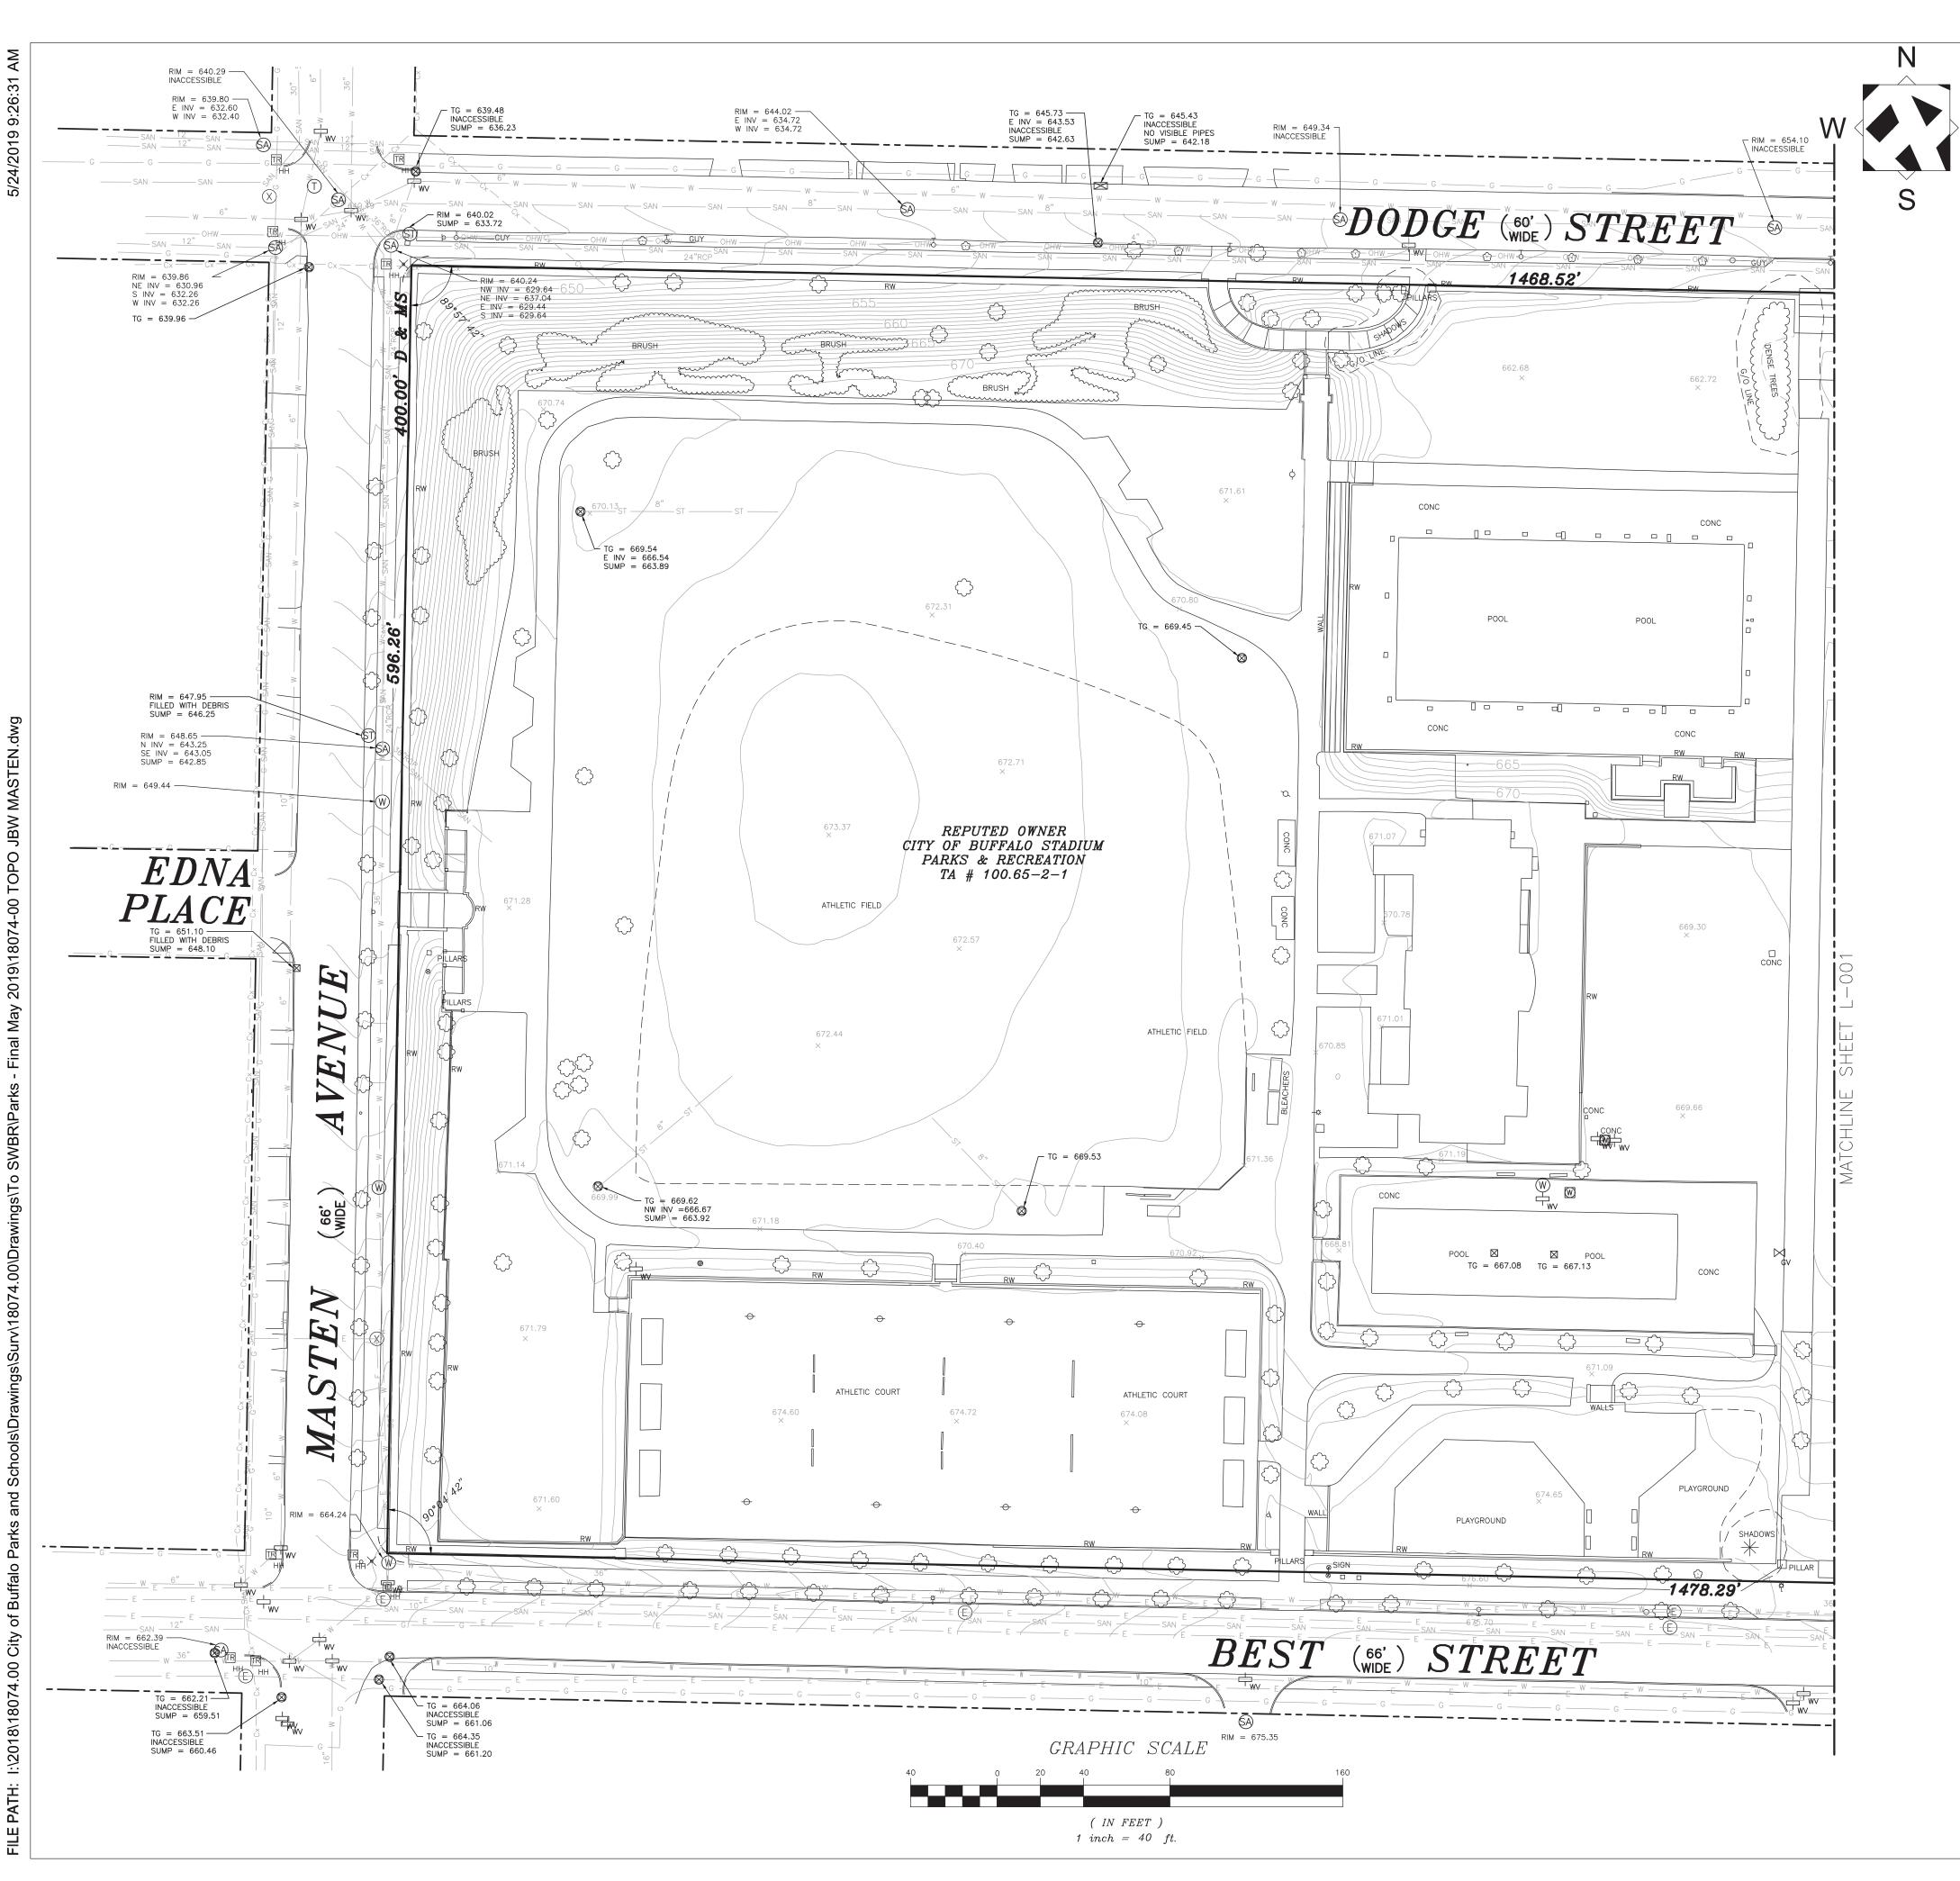



VICINITY MAP

NOT TO SCAL

MAPPING COMPILED BY PHOTOGRAMMETRIC METHODS FROM AERIAL PHOTOGRAPHY FLOWN DECEMBER 2018

THIS SURVEY WAS PREPARED WITHOUT THE BENEFIT OF AN ABSTRACT OF TITLE AND IS SUBJECT TO ANY STATE OF FACTS THAT MAY BE REVEALED BY AN EXAMINATION OF SUCH.

COORDINATES ARE REFERENCED TO THE NEW YORK STATE PLANE COORDINATE SYSTEM WEST ZONE, NAD

ELEVATIONS ARE REFERENCED TO THE NAVD 88 VERTICAL DATUM.

NOTES:

UNAUTHORIZED ALTERATION OR ADDITION TO ANY SURVEY, DRAWING, DESIGN, SPECIFICATION, PLAN OR REPORT IS A VIOLATION OF SECTION 7209, PROVISION 2 OF THE NEW YORK STATE EDUCATION LAW. ONLY COPIES FROM THE ORIGINAL OF THIS SURVEY MAP MARKED WITH AN ORIGINAL OF THE LAND SURVEYOR'S EMBOSSED SEAL AND SIGNATURE SHALL BE CONSIDERED TO BE VALID TRUE COPIES.

ALL UNDERGROUND UTILITIES ARE DEPICTED AT SUE "QUALITY LEVEL C" AND HAVE BEEN LOCATED FROM FIELD SURVEY AND RECORD INFORMATION PROVIDED. THE SURVEYOR MAKES NO GUARANTEE THAT THE UNDERGROUND UTILITIES SHOWN COMPRISE ALL SUCH UTILITIES IN THE AREA, EITHER IN SERVICE OR ABANDONED. THE SURVEYOR FURTHER DOES NOT WARRANT THAT THE UNDERGROUND UTILITIES SHOWN AT QUALITY LEVEL C ARE IN THE EXACT LOCATION INDICATED. ALTHOUGH THEY ARE LOCATED AS ACCURATELY AS POSSIBLE FROM RECORD INFORMATION AVAILABLE, THE SURVEYOR HAS NOT PHYSICALLY LOCATED THE UNDERGROUND UTILITIES.

THE FOLLOWING UTILITY COMPANIES WERE REQUESTED TO PROVIDE THE SURVEYOR THE LOCATION OF THEIR UNDERGROUND FACILITIES THIN THE LIMITS OF THIS SURVEY.

UTILITY COMPANY / AGENCY	FACILITY	RESPONDED	<u>AFFECTED</u>
BUFFALO SEWER AUTHORITY CITY OF BUFFALO CITY OF BUFFALO WATER AUTHORITY DOT REGION 5 BUFFALO NATIONAL FUEL GAS BUFFALO NATIONAL GRID/WEST/ELECTRIC TIME WARNER CABLE — BUFFALO VERIZON BUFFALO	SEWER TRAFFIC SIGNAL & PHONE WATER TRAFFIC GAS ELECTRIC FIBER AND CABLE FIBER AND PHONE	YES YES YES YES YES YES YES YES YES	YES YES YES YES YES YES YES YES

	-GFN	
<u> </u>		
EDGE OF PAVEMENT	<u>POOL</u>	<u>PILE</u> GOLF FAIRWAY
GUARDRAIL	BUILDING UC	UNDER CONSTRUCTION
TREELINE	FOUNDATION	
FENCE GATE	RUINS	RUNWAY
RIVFR	POND, LAKE	AIRFIELD PAVED
HEDGE	PAVED GUTTER	AIRFIELD SHLDR
DIRTROAD	HEADWALL	AIRFIELD PAINT
BUILDING (RES.)	DAM	HELICOPTER PAD
MISCLINE	PIPE END	ABANDONED RR
RETAINING WALL	CEMETERY	PAVED PARKING
CURB	RECREATION UNPAV	UNPAVED PARKING
NDEX OBS_INDEX	TANK	AERIAL TC BOX
INTER OBS_INTER	RECREATION PAVED	PIPE
NDEXD OBS INDEXD	TRAIL	AIR VENT
<u>interd</u> obs_indterd _sidewalk		HEAT PUMP / AC
DECK	CREEK	VALVE
STEPS	SOFTBREAK	LANDSCAPE
GRID (w/text)	<u>HARDBREAK</u> OBSCURED AREA	END EXP JOINT
RR		ROAD CENTERLINE
	UNPAVED SHOULDER	UTILITY BOX
SIGN/OH SIGN	BUILDINGS (TEMP)	GREENS
ROAD PAINT	CANOPY	TRAPS_BUNKERS
PKG PAINT	FENCE GATE	TEES
TRAVELWAY	PHONE	<u>Indefinite</u> <u>area</u>
PAVED DRIVE	GUY	CULTIVATED FIELD
UNPAVED DRIVE BRUSH	RAMP SMOKE	<u>DOCK</u> BRIDGE ROAD
~~~~~~~~~~~~~~~~~~~~~~~~~~~~~~~~~~~~~~~	OH_PIPE	BRIDGE CURB
CONTEXT 10 — BRIDGE	OH WALK	BRIDGE SIDEWALK
MAPPING LIMITS	CONVEYOR	MID EXP JOINT
	LANDFILL	BRIDGE-BREAK
WALL	OPEN STORAGE	OBSCURED BREAK
ROUND		
□ CB OCB	<u>SYMBOLS</u>	Ł HANDI−CAP
SQUARE	-O- PWRPOLE	<ul><li>VALVE</li></ul>
□ CB	♥ FIREHYD	• FLAG
DECIDUOUS BUSH	₩ SWAMP	UNOB
* CONIFEROUS BUSH	- PWRPOLEL	□ RAILSIG
× TC	TOWER (LINE)	
⊚ MH	( CULV (LINE) † CEMETERY	
* LAMPOST	AC or HEAT P	* RUNLIGHT
C DECIDUOUS TREE	→ POLES (MISC)	* IAXLIGHI
* CONIFEROUS TREE	× DTM SPOT	* TRASIG • TREEBOLE
CLONI	× OBS DTM SPO	
p SIGN POST	+ ANTENNA	VERT
0.0	SAT.DISH	△ HOR
× SPOT	— GUY (LINE)	▲ HV



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Drawn By: HC
Checked By: DLP
Project Manager: DLP

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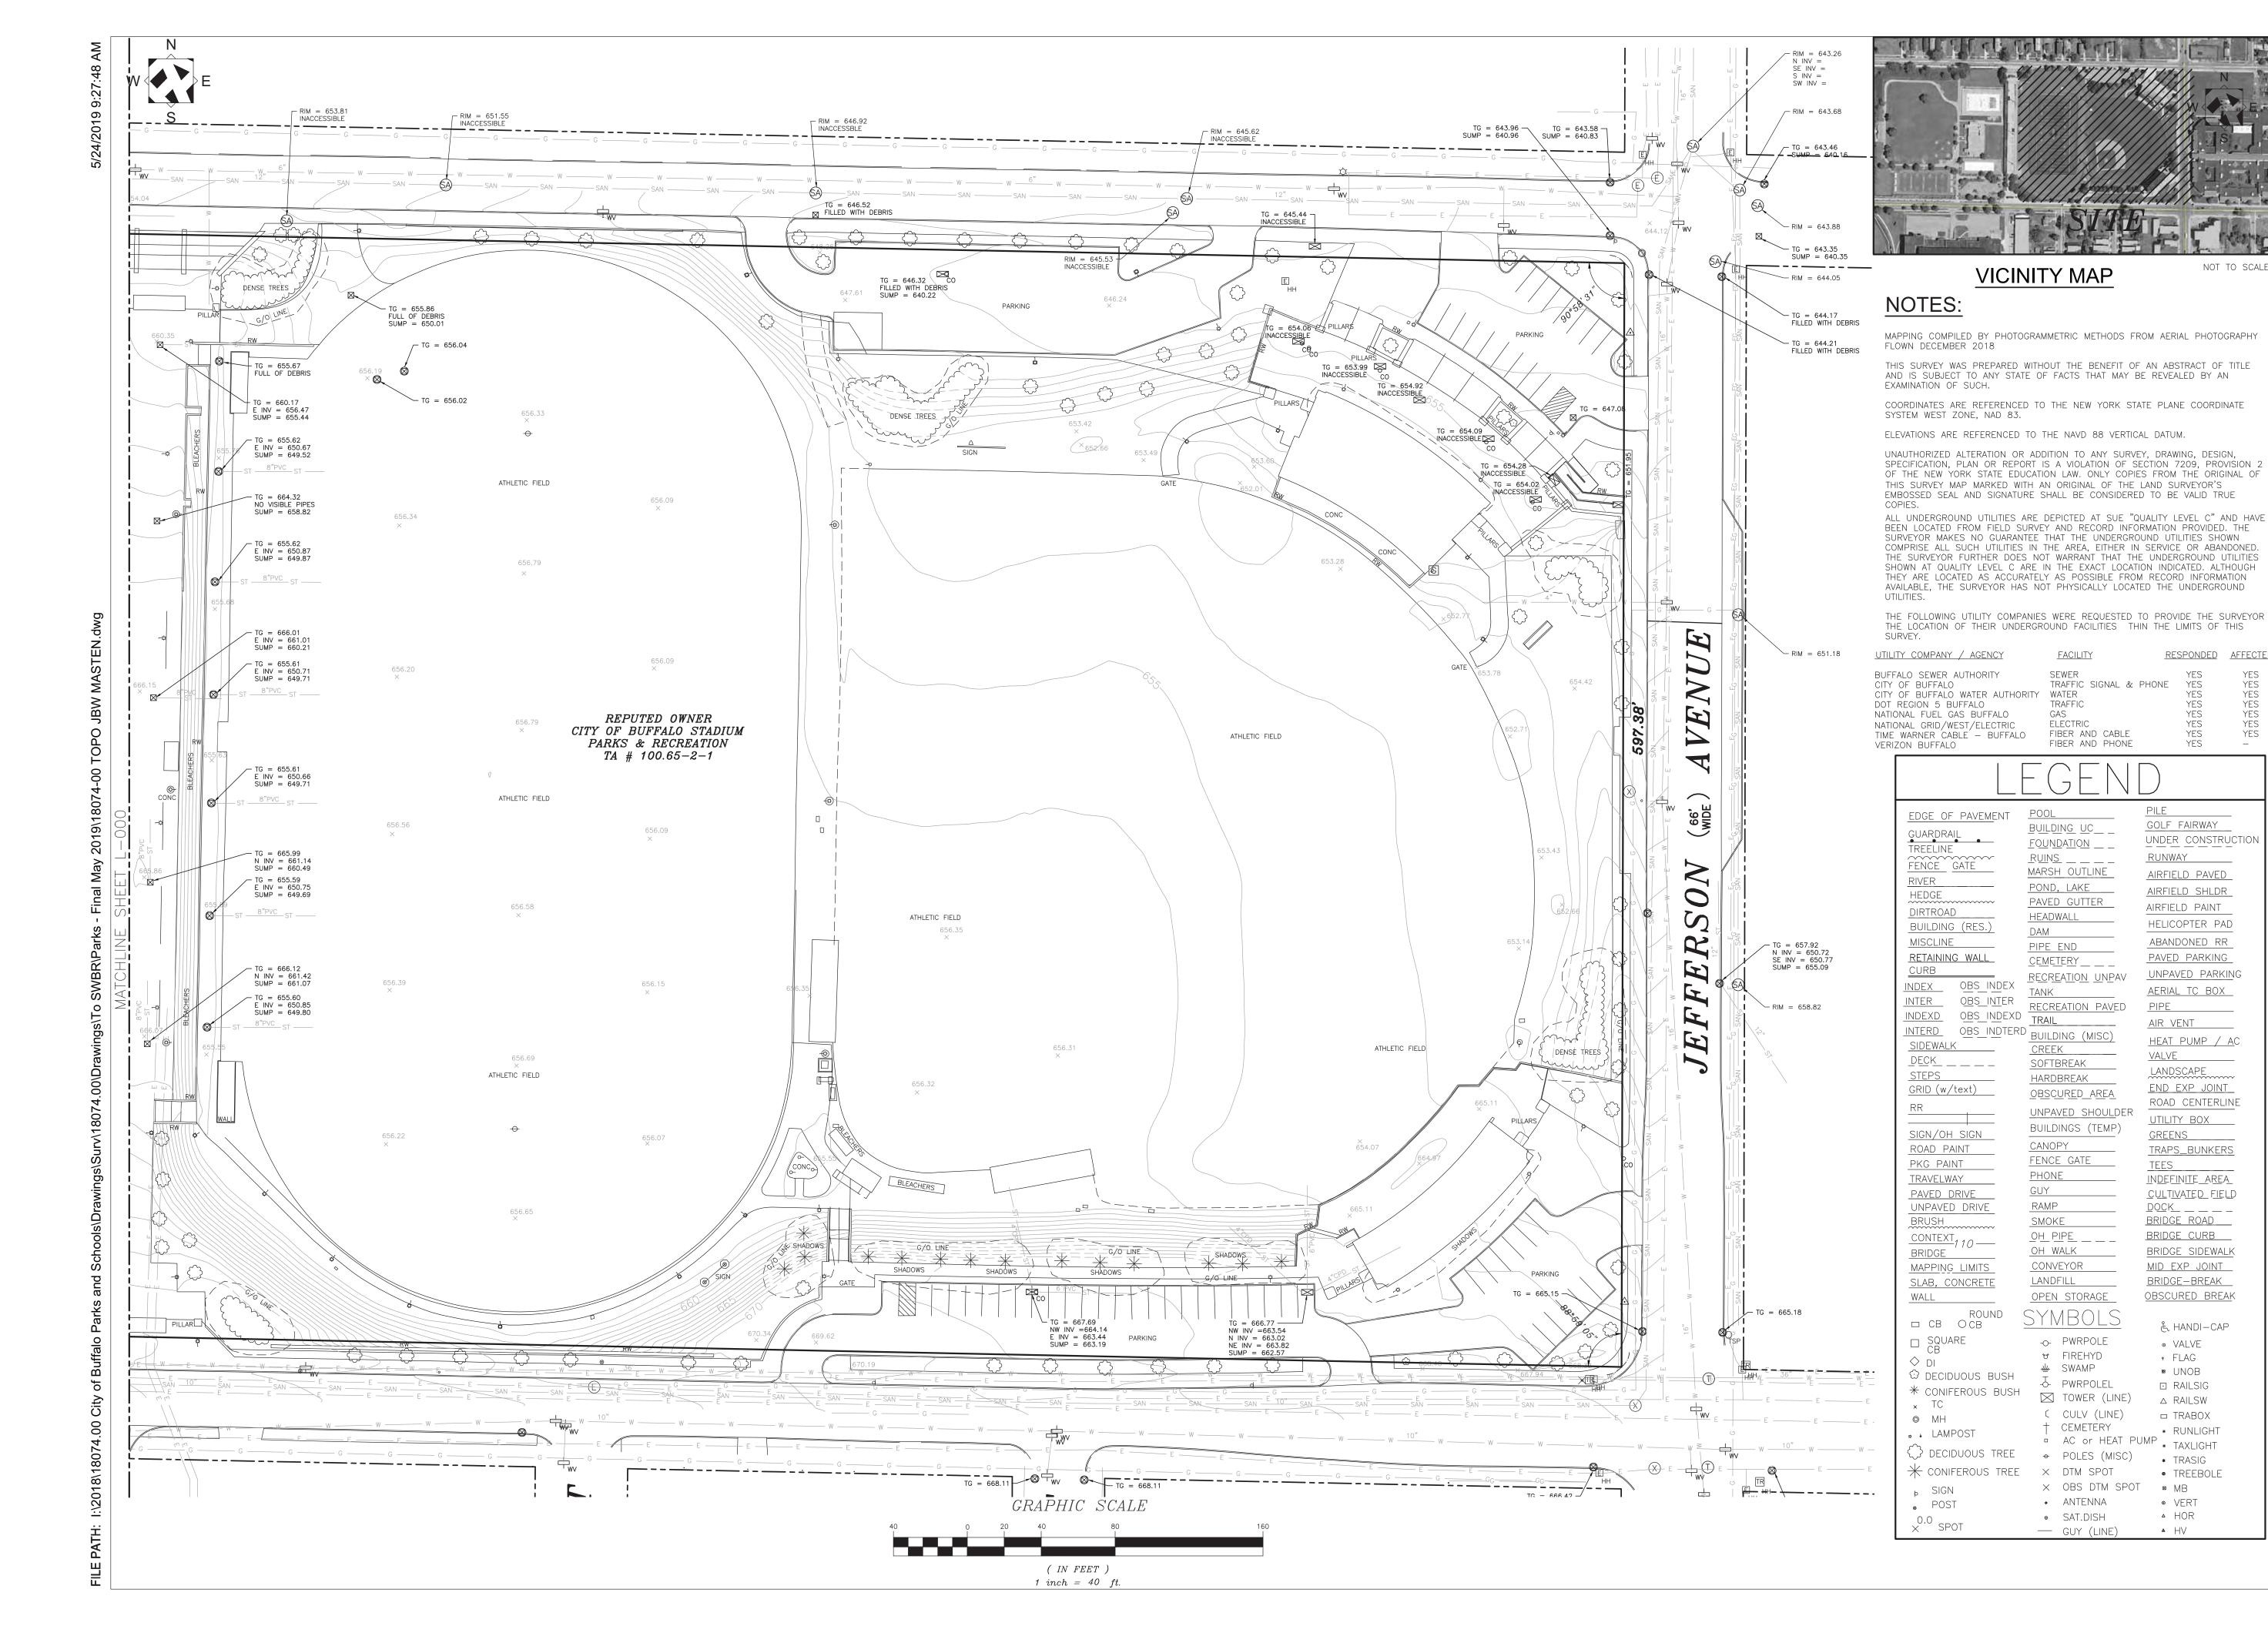
City of Buffalo Parks & Buffalo Public School Facilities Survey & Design Development SWBR Project Number 18630.00

Community Foundation for Greater Buffalo 726 Exchange Street, Suite 525 Buffalo, NY 14210

L-000

JBW / Masten

Existing Conditions/Survey (West)





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NOT TO SCALE

RESPONDED AFFECTED

YES

YES

YES

YES

GOLF FAIRWAY

AIRFIELD PAVED

AIRFIELD SHLDR

HELICOPTER PAD ABANDONED RR

PAVED PARKING

AERIAL TO BOX

AIR VENT

<u>VALVE</u>

TEES

LANDSCAPE

END EXP JOINT

UTILITY BOX

GREENS

TRAPS_BUNKERS

<u>INDEFINITE_AREA</u>

CULTIVATED FIELD

<u>DOCK_ _ _ _ _ _ </u>

BRIDGE ROAD

BRIDGE CURB

BRIDGE SIDEWALK

لِّ HANDI-CAP

VALVE

FLAG

UNOB

□ RAILSIG

△ RAILSW

* TRASIG

VERT △ HOR

▲ HV

□ TRABOX

* RUNLIGHT

TREEBOLE

MID EXP JOINT

ROAD CENTERLINE

HEAT PUMP / AC

AIRFIELD PAINT

RUNWAY

UNDER CONSTRUCTION

YES YES YES YES YES YES



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**Community Foundation for Greater Buffalo** 

726 Exchange Street, Suite 525 Buffalo, NY 14210

L-001 JBW / Masten

Existing Conditions/Survey (East)

	SITE DEMOLITION NOTES
NO.	DESCRIPTION
1	REMOVE AND DISPOSE OF FENCE, POSTS, AND FOOTERS
2	REMOVE AND DISPOSE OF WALLS
3	REMOVE AND DISPOSE OF CONCRETE STAIRS AND HANDRAILS
4	EXISTING STONE WALL TO REMAIN
5	REMOVE AND SALVAGE EXISTING BLEACHER FOR REUSE
6	REMOVE AND DISPOSE OF PAVEMENT UP TO EDGE OF POOL
7	REMOVE AND SALVAGE (FOR REUSE ON SITE) EXISTING STONE BLOCKS
8	REMOVE AND SALVAGE GATES
9	REMOVE AND DISPOSE OF EXISTING DUMPSTER ENCLOSURE, DUMPSTER TO REMAIN
10	REMOVE AND DISPOSE OF CHAIN LINK GATES, TO BE REPLACED
11	REMOVE AND SALVAGE LIFE GUARD STANDS AND POOL LADDER RAILS FOR REUSE
12	REMOVE AND DISPOSE OF POST LIGHT
13	REMOVE AND DISPOSE OF CONCRETE PILLAR
14	REMOVE ALL VEGETATION FROM JOINTS OF RETAINING WALL
15	REMOVE DEAD, EARLY SUCCESSIONAL, INVASIVE SPECIES, AND VOLUNTARY TREES ON EMBANKMENT
16	REMOVE AND DISPOSE OF EXISTING SYNTHETIC TURF FIELD. REFER TO SITE LAYOUT PLANS FOR REPLACEMENT
17	TRACK, "D" ZONE, AND ALL RESILIENT SURFACE IMPROVEMENTS. (1) PROTECT SYNTHETIC TURF FIELD 40' FROM

EDGE OF TRACK (2) CLEAN EXISTING TRENCH DRAIN ON INSIDE

PERIMETER OF TRACK WITH SYNTHETIC TURF (3) PRESSURE WASH (4) INCLUDE MINOR PATCHING (5) RESPRAY COLORED POLYURÉTHANE SURFACE AND (6) RESTRIPE ALL LINES, NUMBERS, AND SYMBOLS. REFER TO SITE LAYOUT PLANS FOR

REPLACEMENT.

SITE DEMOLITION NOTES
DESCRIPTION
REMOVE AND DISPOSE OF WOOD GUIDE RAIL
ALL EXISTING HANDRAILS TO BE POWERWASHED AND REPAINTED TO MATCH EXISTING FINISH

21 EXISTING SCOREBOARD TO REMAIN

NO. 18

#### GENERAL DEMOLITION NOTES

DESCRIPTION	
REMOVE AND DISPOSE OF WOOD GUIDE RAIL	1. CONTRACTOR TO REMOVE & DISPOSE OF ALL
ALL EXISTING HANDRAILS TO BE POWERWASHED AND REPAINTED TO MATCH EXISTING FINISH	ITEMS INDICATED & ANY ITEMS INCIDENTAL TO THE CONSTRUCTION AS REQUIRED.
DEMOLISH EXISTING SINGLE STORY STRUCTURE (WITH	2. CONTRACTOR TO PROTECT/PRESERVE ALL

ESERVE ALL EXISTING ITEMS TO REMAIN, INCLUDING BUT NOT LIMITED TO BUILDINGS, PAVEMENT, OVERHEAD & BURIED UTILITIES, TREES, LANDSCAPE, ETC. DAMAGE TO ITEMS SCHEDULED TO REMAIN SHALL BE REPAIRED OR REPLANTED AT NO ADDITIONAL COST TO THE OWNER.

3. UTILITIES SHOWN ARE APPROXIMATE. CONTRACTOR SHALL HAVE ALL UNDERGROUND FACILITIES LOCATED AND MARKED PRIOR TO EXCAVATION/DEMOLITION CONSTRUCTION. 4. REMOVE CONCRETE SIDEWALK AND/OR

PAVEMENT TO THE LIMITES INDICATED. SAW CUT CONCRETE TO THE NEAREST EXISTING CONTROL/EXPANSION JOINT. 5. CONTRACTOR SHALL MARK TREES

(DESIGNATED FOR REMOVAL) IN THE FIELD AND OBTAIN OWNER'S ON-SITE REPRESENTATIVE APPROVAL PRIOR TO BEGINNING REMOVALS. 6. CLEAR AND GRUB ALL VOLUNTEER


VEGETATION, AS INDICATED. 7. ALL EXISTING SITE FURNITURE TO BE REMOVED AND DISPOSED OF UNLESS OTHERWISE NOTED.

#### DEMOLITION LEGEND



DEMOLISH EXISTING BUILDING AND DISPOSE OFF SITE. CONCRETE FOUNDATIONS/WALLS/SLABS AND GRANULAR BASE MATERIALS TO BE REMOVED.

EXISTING PAVEMENT, CURBING, AND AGGREGATE BASE MATERIAL TO BE REMOVED AND DISPOSED OFF SITE.

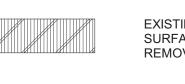

EXISTING PLAYGROUND EQUIPMENT, SAFETY SURFACE MATERIAL (EWF), AND FOOTINGS TO BE REMOVED AND DISPOSED OFF SITE.



SITE ELEMENT TO BE REMOVED AND DISPOSED OFF SITE IN A LEGAL MATTER.




SAW CUT LINE



TREE TO REMAIN AND BE PROTECTED



TREE TO BE REMOVED

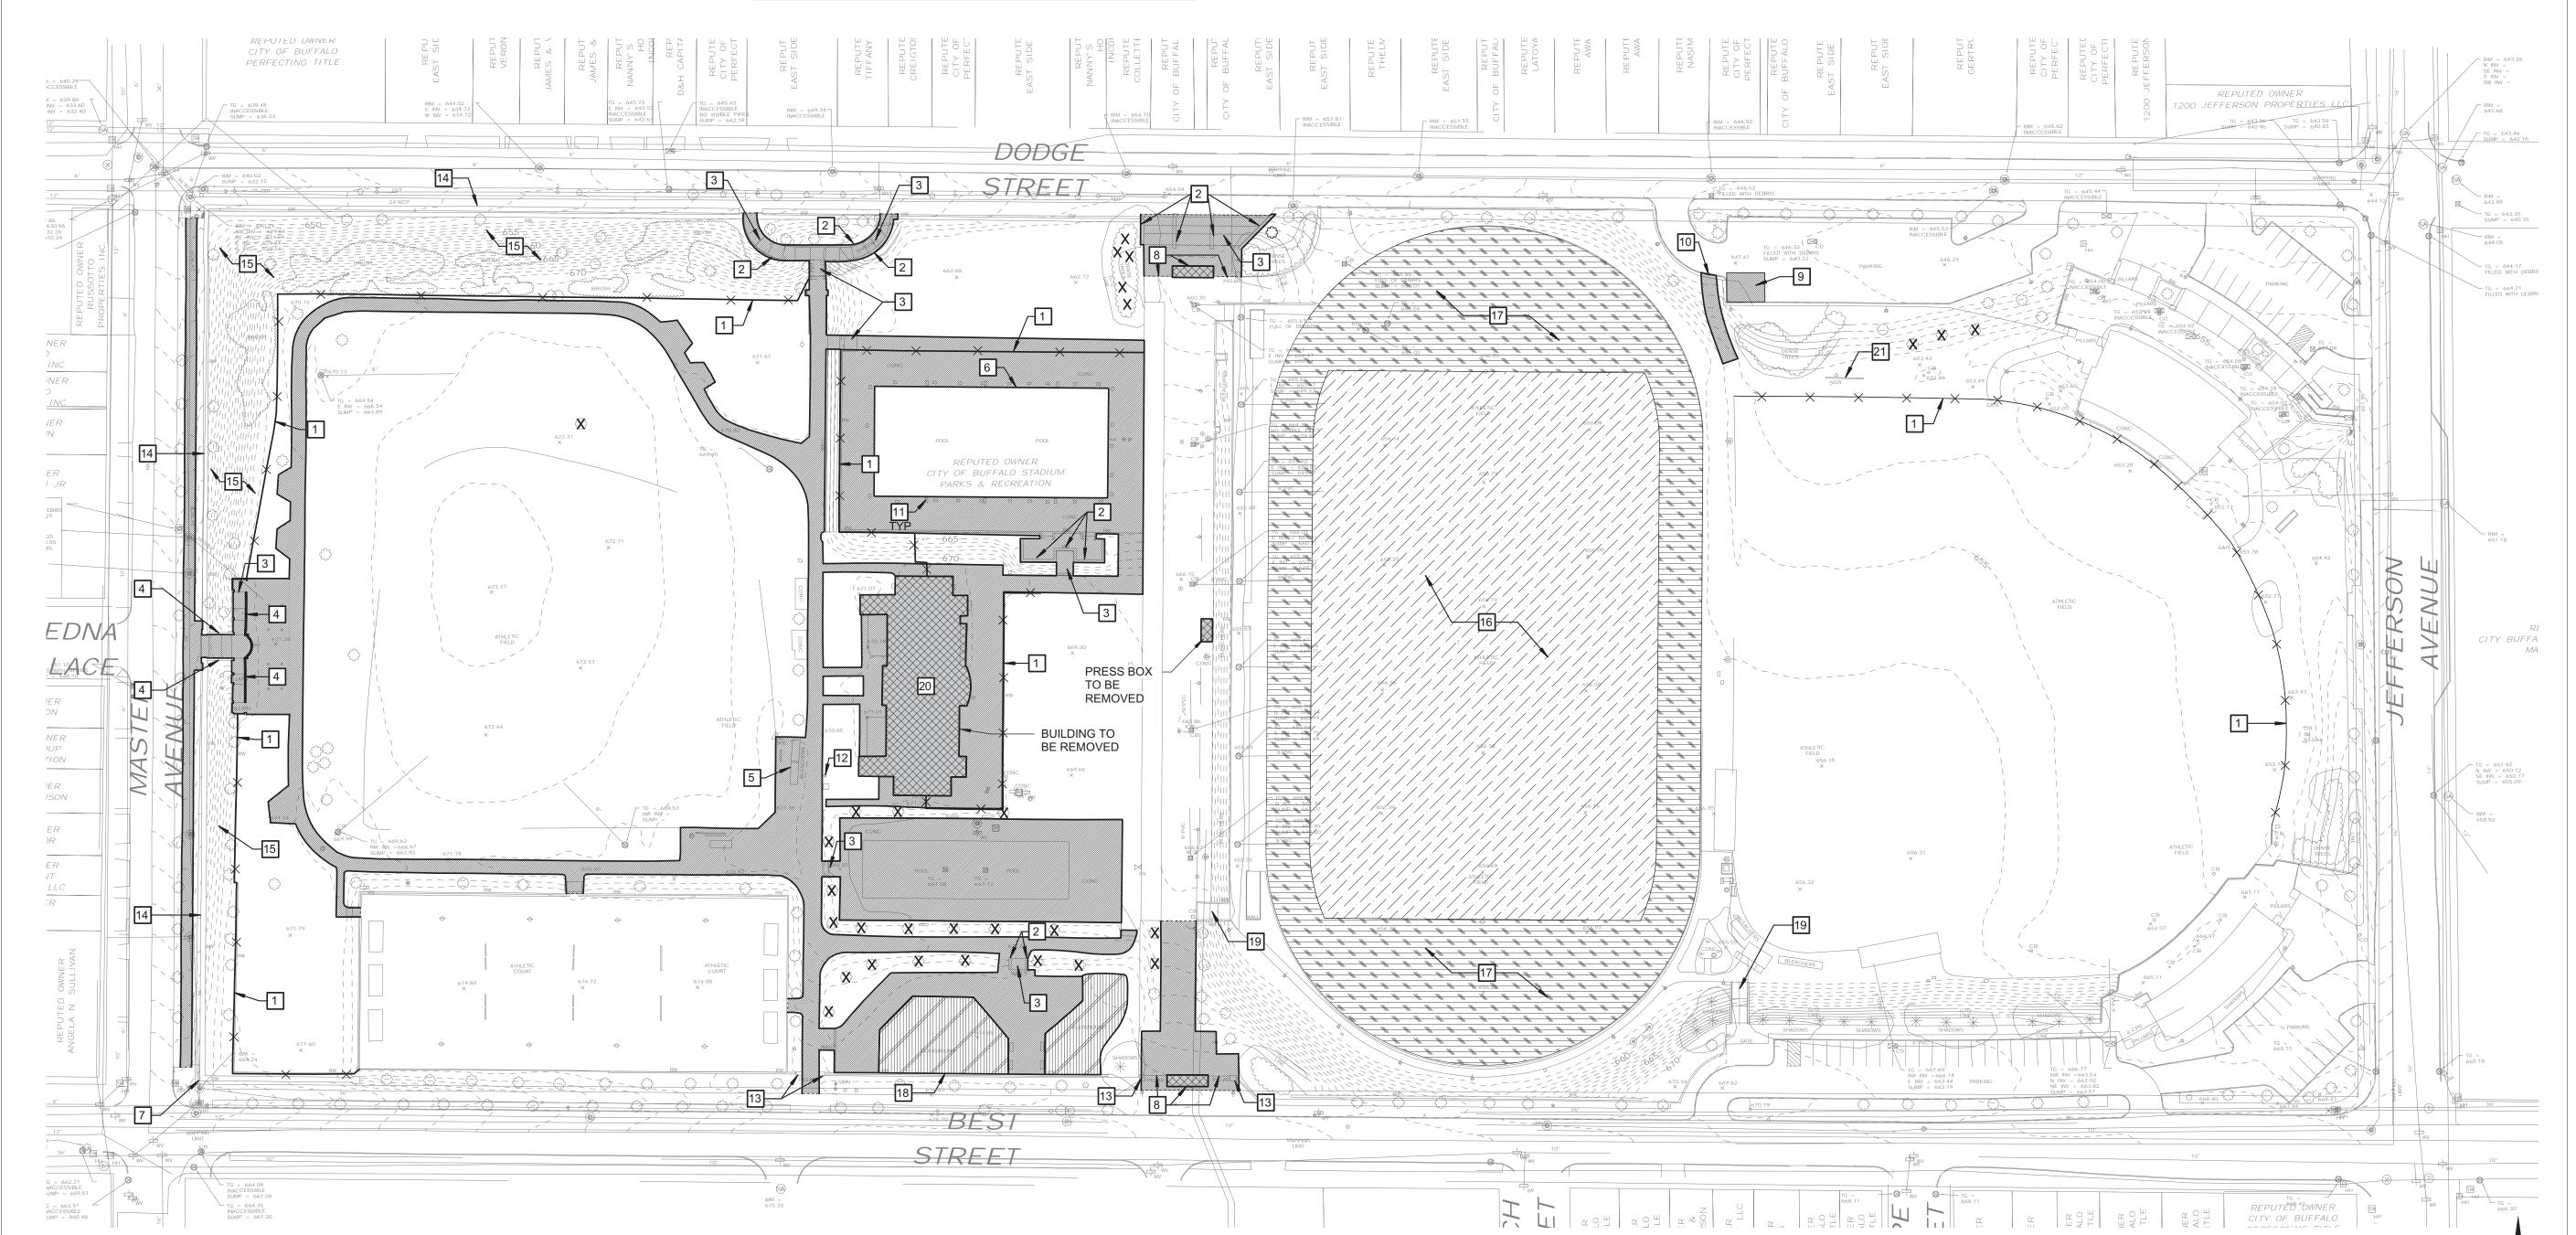

Checked By:

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Project Manager: BP

Revisions

City of Buffalo Parks & Buffalo Public School Facilities Survey & Design Development SWBR Project Number 18630.00

**Community Foundation for** Greater Buffalo

726 Exchange Street, Suite 525 Buffalo, NY 14210

L-002 JBW / Masten **Demolition Plan** 


03.29.2019 Design Development Set

JBW/MASTEN DEMOLITION PLAN

#### LANDSCAPE AND PAVING LEGEND

---- PROPERTY LINES




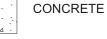









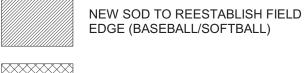

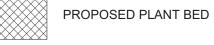

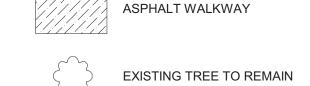



FIELD LIGHTING

PATHWAY LIGHTING

LAMPPOLE TO REMAIN

SECURITY CAMERA

SCOREBOARD

COMBINATION FOOTBALL / SOCCER GOAL

IIII BIKE RACK

O DOG WASTE STATION

6' METAL BENCH

GRASS TURF FIELD

COMPLIES WITH NFHS FIELD SIZE STANDARDS FOR SOFTBALL

#### SOFTBALL FIELD CONSTRUCTION NOTES

- 1. CLAY INFI
  - A. STRIP AND STOCKPILE CLAY FROM EXISTING FIELDS FOR REUSE B. EXCAVATE 6" AREA OF CLAY INFIELD (~170 c.y.)
  - C. IMPORT SPREAD AND COMPACT 3" COURSE BEDDING SAND D. REUSE AND IMPORT 3" CLEAN MATERIAL OVER SAND BASE E. INSTALL CLAY BRICKS AT PITCHERS MOUND, HOME PLATE, BATTER BOXES AND CATCHERS BOX
- F. FINE GRADE CLAY AND COMPACT
  2. OUTFIELD:
- A. IMPORT TOPSOIL (130 c.y.) AND SPREAD TO ACHIEVE DESIGN GRADES
- B. FINE RAKE AND SEED C. PERFORM GROW IN MOWINGS AND FERTILIZATION
- C. PERFORM GROW IN MOWINGS AND FERTILIZATI


#### SLOPE RESTORATION NOTES

- CLEAR AND GRUB DEAD TREES AND STUMPS
   MOW OR WEED WHIP ALL GRASS VEGETATION ON SLOPE AND
- REMOVE FROM SITE
- 3. IMPORT 200 c.y. TOPSOIL, ROUGH GRADE WITH TRACK FINISH
- 4. HYDROSEED SLOPES (45,000 S.F.) WITH ANNUAL RYE AND TALL FESCUE SEED MIX AND AND __ TO STABILIZE SLOPE //





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Drawn By: MMF
Checked By: BP

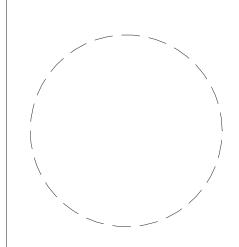Project Manager: BP

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SWBR Project Number 18630.00

Community Foundation for

**Greater Buffalo**726 Exchange Street, Suite 525
Buffalo, NY 14210

L-101 JBW / Masten

Site Layout Plan (West)



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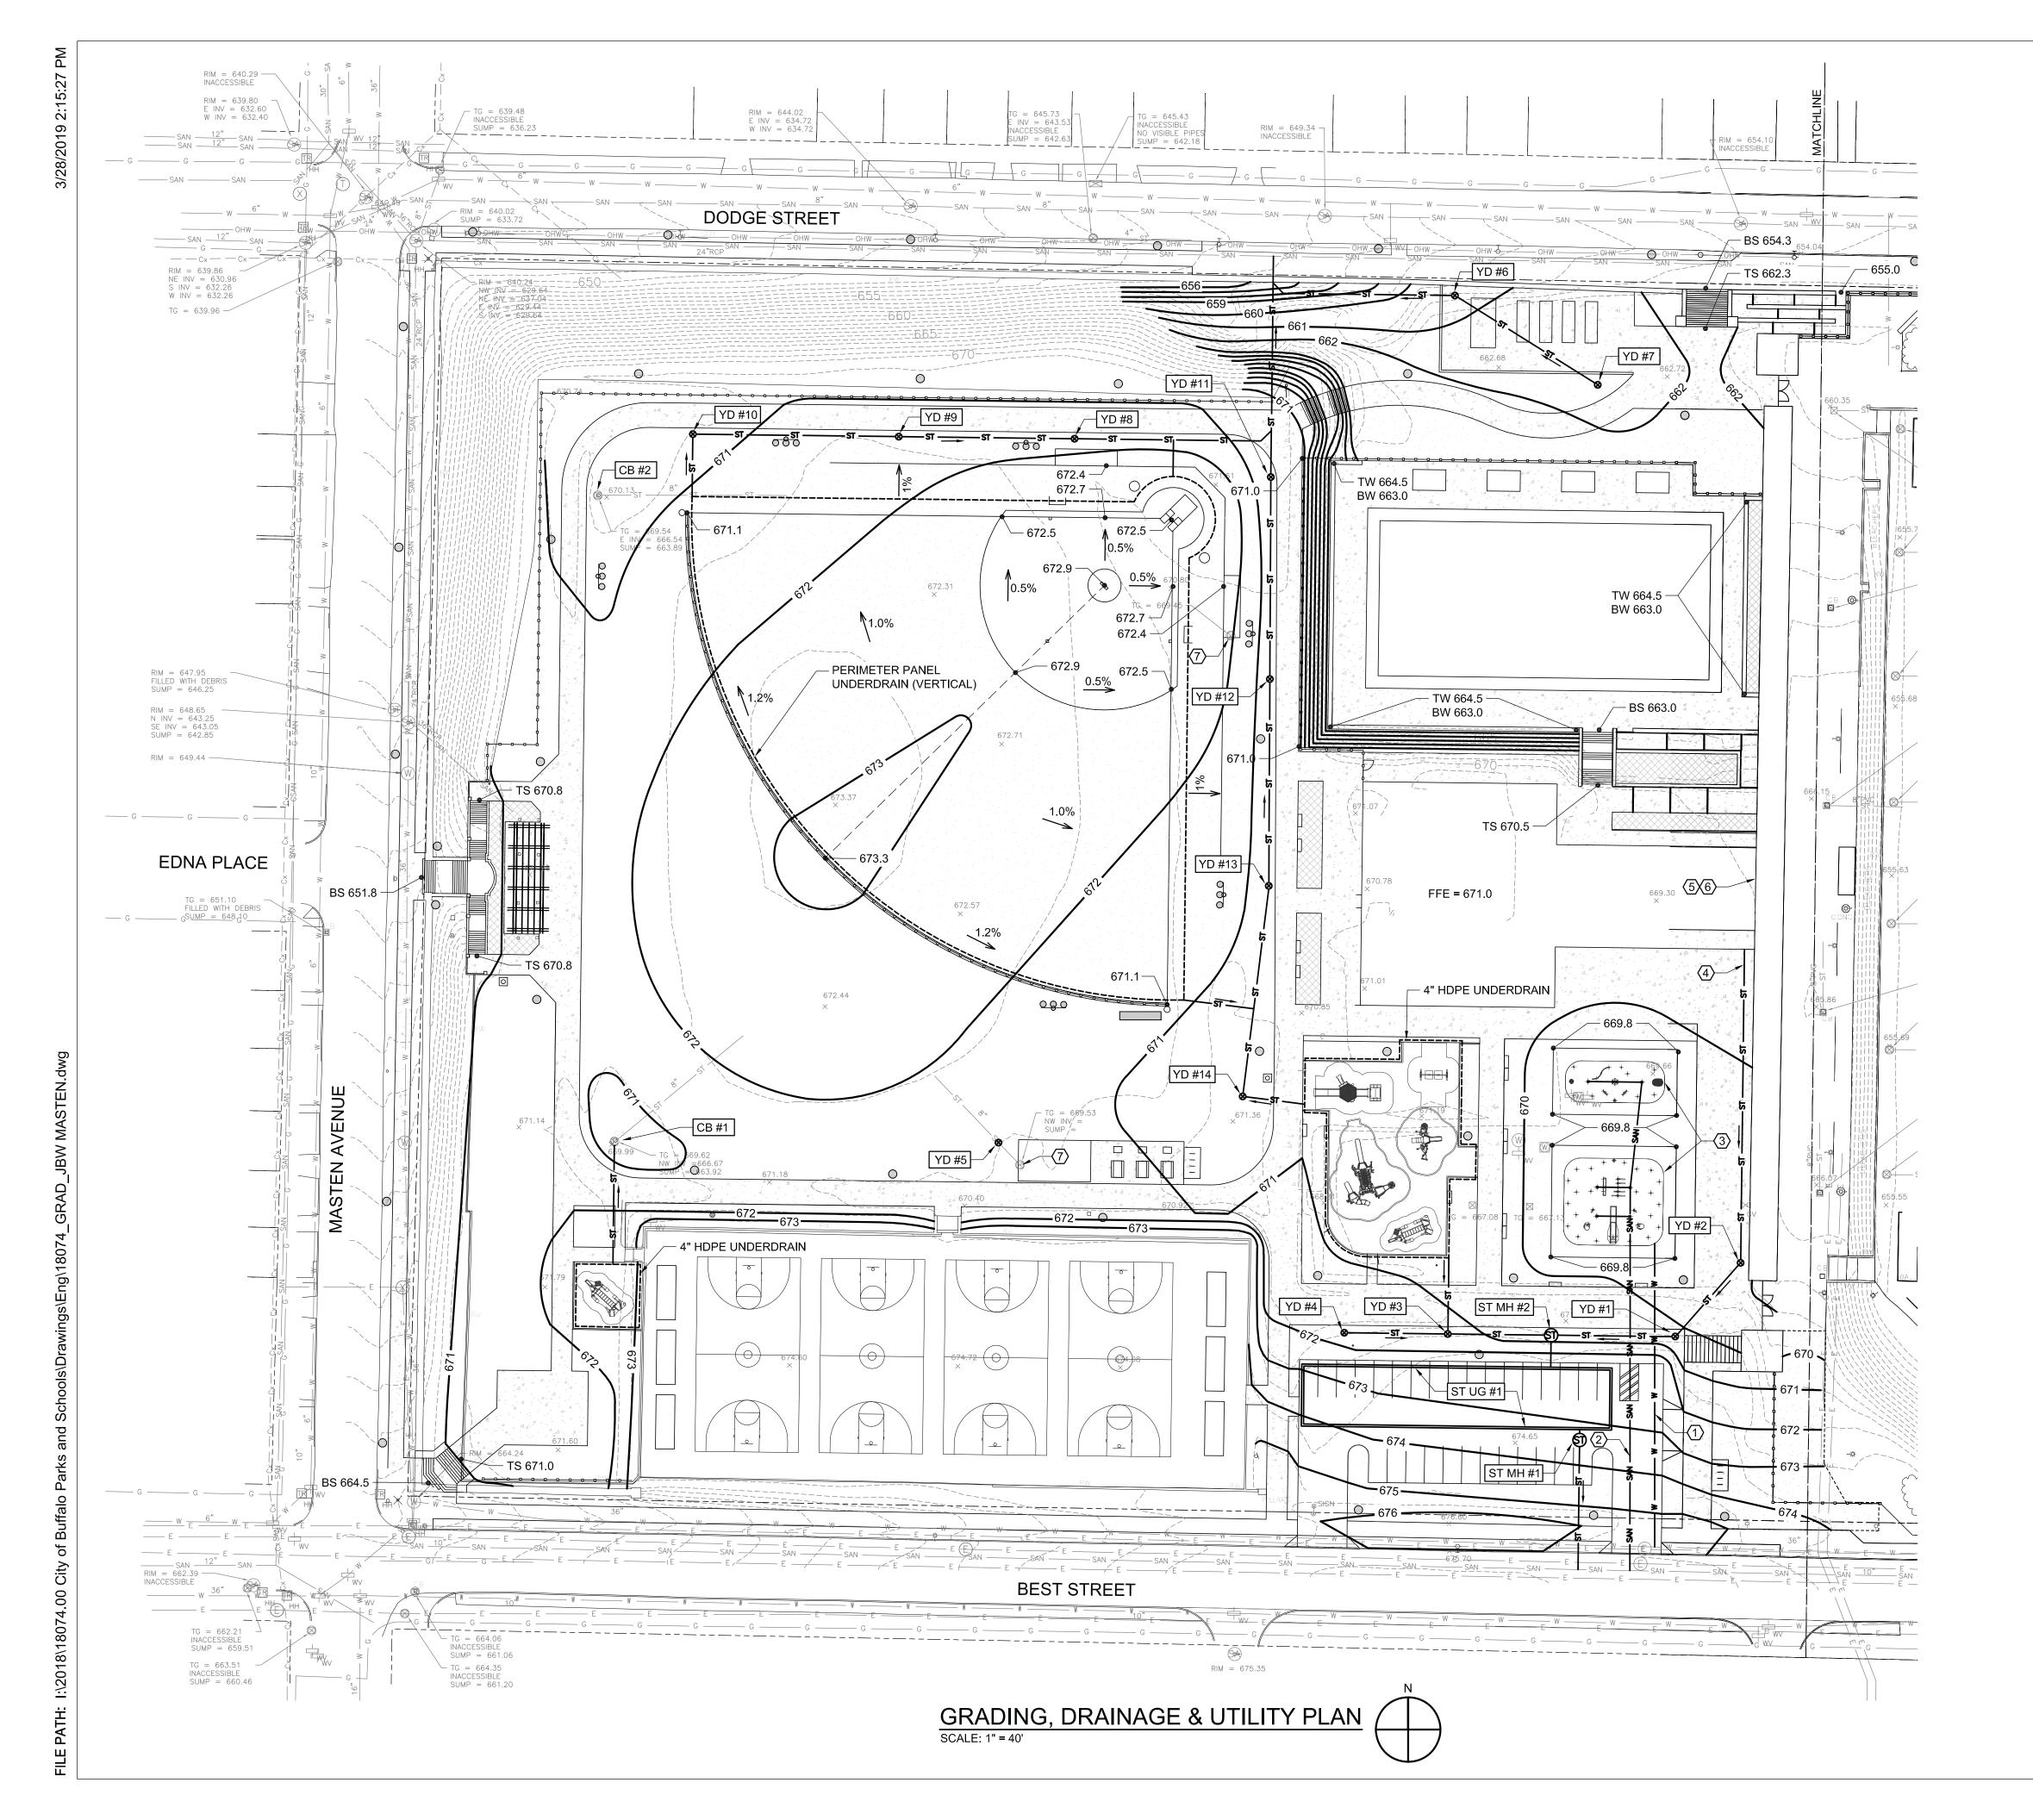
City of Buffalo Parks & Buffalo Public School Facilities Survey & Design Development SWBR Project Number 18630.00

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L-102 JBW / Masten

Site Layout Plan (East)



#### GRADING & UTILITY NOTES

- STORM PIPING TO BE HDPE UNLESS OTHERWISE INDICATED. SANITARY SEWER PIPING TO BE SDR-35 PVC. WATER PIPING TO BE TYPE K COPPER OR DUCTILE IRON. PIPE SIZING TO BE DETERMINED DURING FINAL DESIGN.
- ALL UNDERDRAIN PIPING TO BE 4" DIAMETER PERFORATED HDPE OR PANEL UNDERDRAIN AS INDICATED ON PLANS. UNDERDRAIN AND PANEL DRAIN PIPE TO SLOPE TOWARD CONNECTIONS TO STORM SYSTEM.
- 3. THE PROJECT MAY BE SUBJECT TO THE REQUIREMENTS OF NYSDEC SPDES GENERAL PERMIT FOR STORMWATER DISCHARGES FROM CONSTRUCTION ACTIVITY, GP-0-15-002. A STORMWATER POLLUTION PREVENTION PLAN (SWPPP) IS REQUIRED FOR THE PROJECT AS WELL AS EROSION AND SEDIMENT CONTROL PLANS PREPARED IN ACCORDANCE WITH THE "NEW YORK STATE STANDARDS AND SPECIFICATIONS FOR EROSION AND SEDIMENT CONTROL."
- 4. UNDERGROUND DETENTION LOCATION AND SIZE IS SCHEMATIC ONLY. STORMWATER MANAGEMENT SYSTEM (WATER QUANTITY AND QUALITY MEASURES) TO BE DESIGNED TO MEET SWPPP REQUIREMENTS DURING FINAL DESIGN.

UTILITY KEY NOTES			
1	NEW WATER SERVICE LATERAL TO CONNECT TO EX. 36" WATER MAIN		
2	NEW DRAIN LINE FOR SPLASH PADS TO CONNECT TO EX. 10" SANITARY SEWER MAIN		
3	SPLASH PAD SURFACE TO SLOPE 2% FROM PERIMETER TOWARDS SPLASH PAD DRAINS		
4	NEW ROOF DRAINAGE STORM LATERAL TO CONNECT FROM BUILDING TO TO NEW STORM LINE		
(5)	WATER SERVICE FOR NEW BUILDING TO CONNECT TO EX. BUILDING WATER SERVICE LINE		
6	SANITARY SEWER SERVICE FOR NEW BUILDING TO CONNECT TO EX. BUILDING SEWER LINE		
7	EX. CATCH BASIN TO BE REMOVED AND PIPE OUT CAPPED AND ABANDONED IN PLACE		

#### STORM DRAINAGE STRUCTURES

I.D.	DESCRIPTION	RIM	INVER
ST MH #1	STORM MANHOLE	673.4	665.0
ST MH #2	STORM MANHOLE	670.8	665.2
CB #1	EX. CATCH BASIN	669.6	666.7
CB #2	EX. CATCH BASIN	ADJUST 670.0	
YD #1	YARD DRAIN	670.1	665.7
YD #2	YARD DRAIN	669.5	666.0
YD #3	YARD DRAIN	671.1	666.6
YD #4	YARD DRAIN	671.5	668.0
YD #5	YARD DRAIN	671.2	MATCH EX
YD #6	YARD DRAIN	660.8	657.3
YD #7	YARD DRAIN	661.6	658.1
YD #8	YARD DRAIN	671.7	665.2
YD #9	YARD DRAIN	671.4	666.1
YD #10	YARD DRAIN	670.6	667.1
YD #11	YARD DRAIN	670.5	664.1
YD #12	YARD DRAIN	670.5	664.9
YD #13	YARD DRAIN	670.2	665.7
YD #14	YARD DRAIN	670.0	666.5
ST UG #1	STORM UNDERGROUND DETENTION SYSTEM	VARIES	665.0


#### LEGEND

600	EX. CONTOUR
<del></del>	PROP. CONTOUR
667.0	PROP. SPOT ELEVATION
ST	STORM DRAINAGE PIPE
SAN	SANITARY SEWER PIPE
——— w——	WATER PIPE
	STORM UNDERDRAIN OR PANEL DRAIN
	STORM TRENCH DRAIN
<b>(ST)</b>	STORM DRAINAGE MANHOLE
	CATCH BASIN
8	YARD DRAIN
(SA)	SANITARY SEWER MANHOLE
° co	CLEANOUT
$\Delta$	FIRE HYDRANT
$\bowtie$	WATER VALVE
СВ	CATCH BASIN
YD	YARD DRAIN
ST MH	STORM DRAINAGE MANHOLE
SS MH	SANITARY SEWER MANHOLE
TW / BW	TOP OF WALL / BOTTOM OF WALL
TS/BS	TOP OF STAIR / BOTTOM OF STAIR



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Project Manager: DLP

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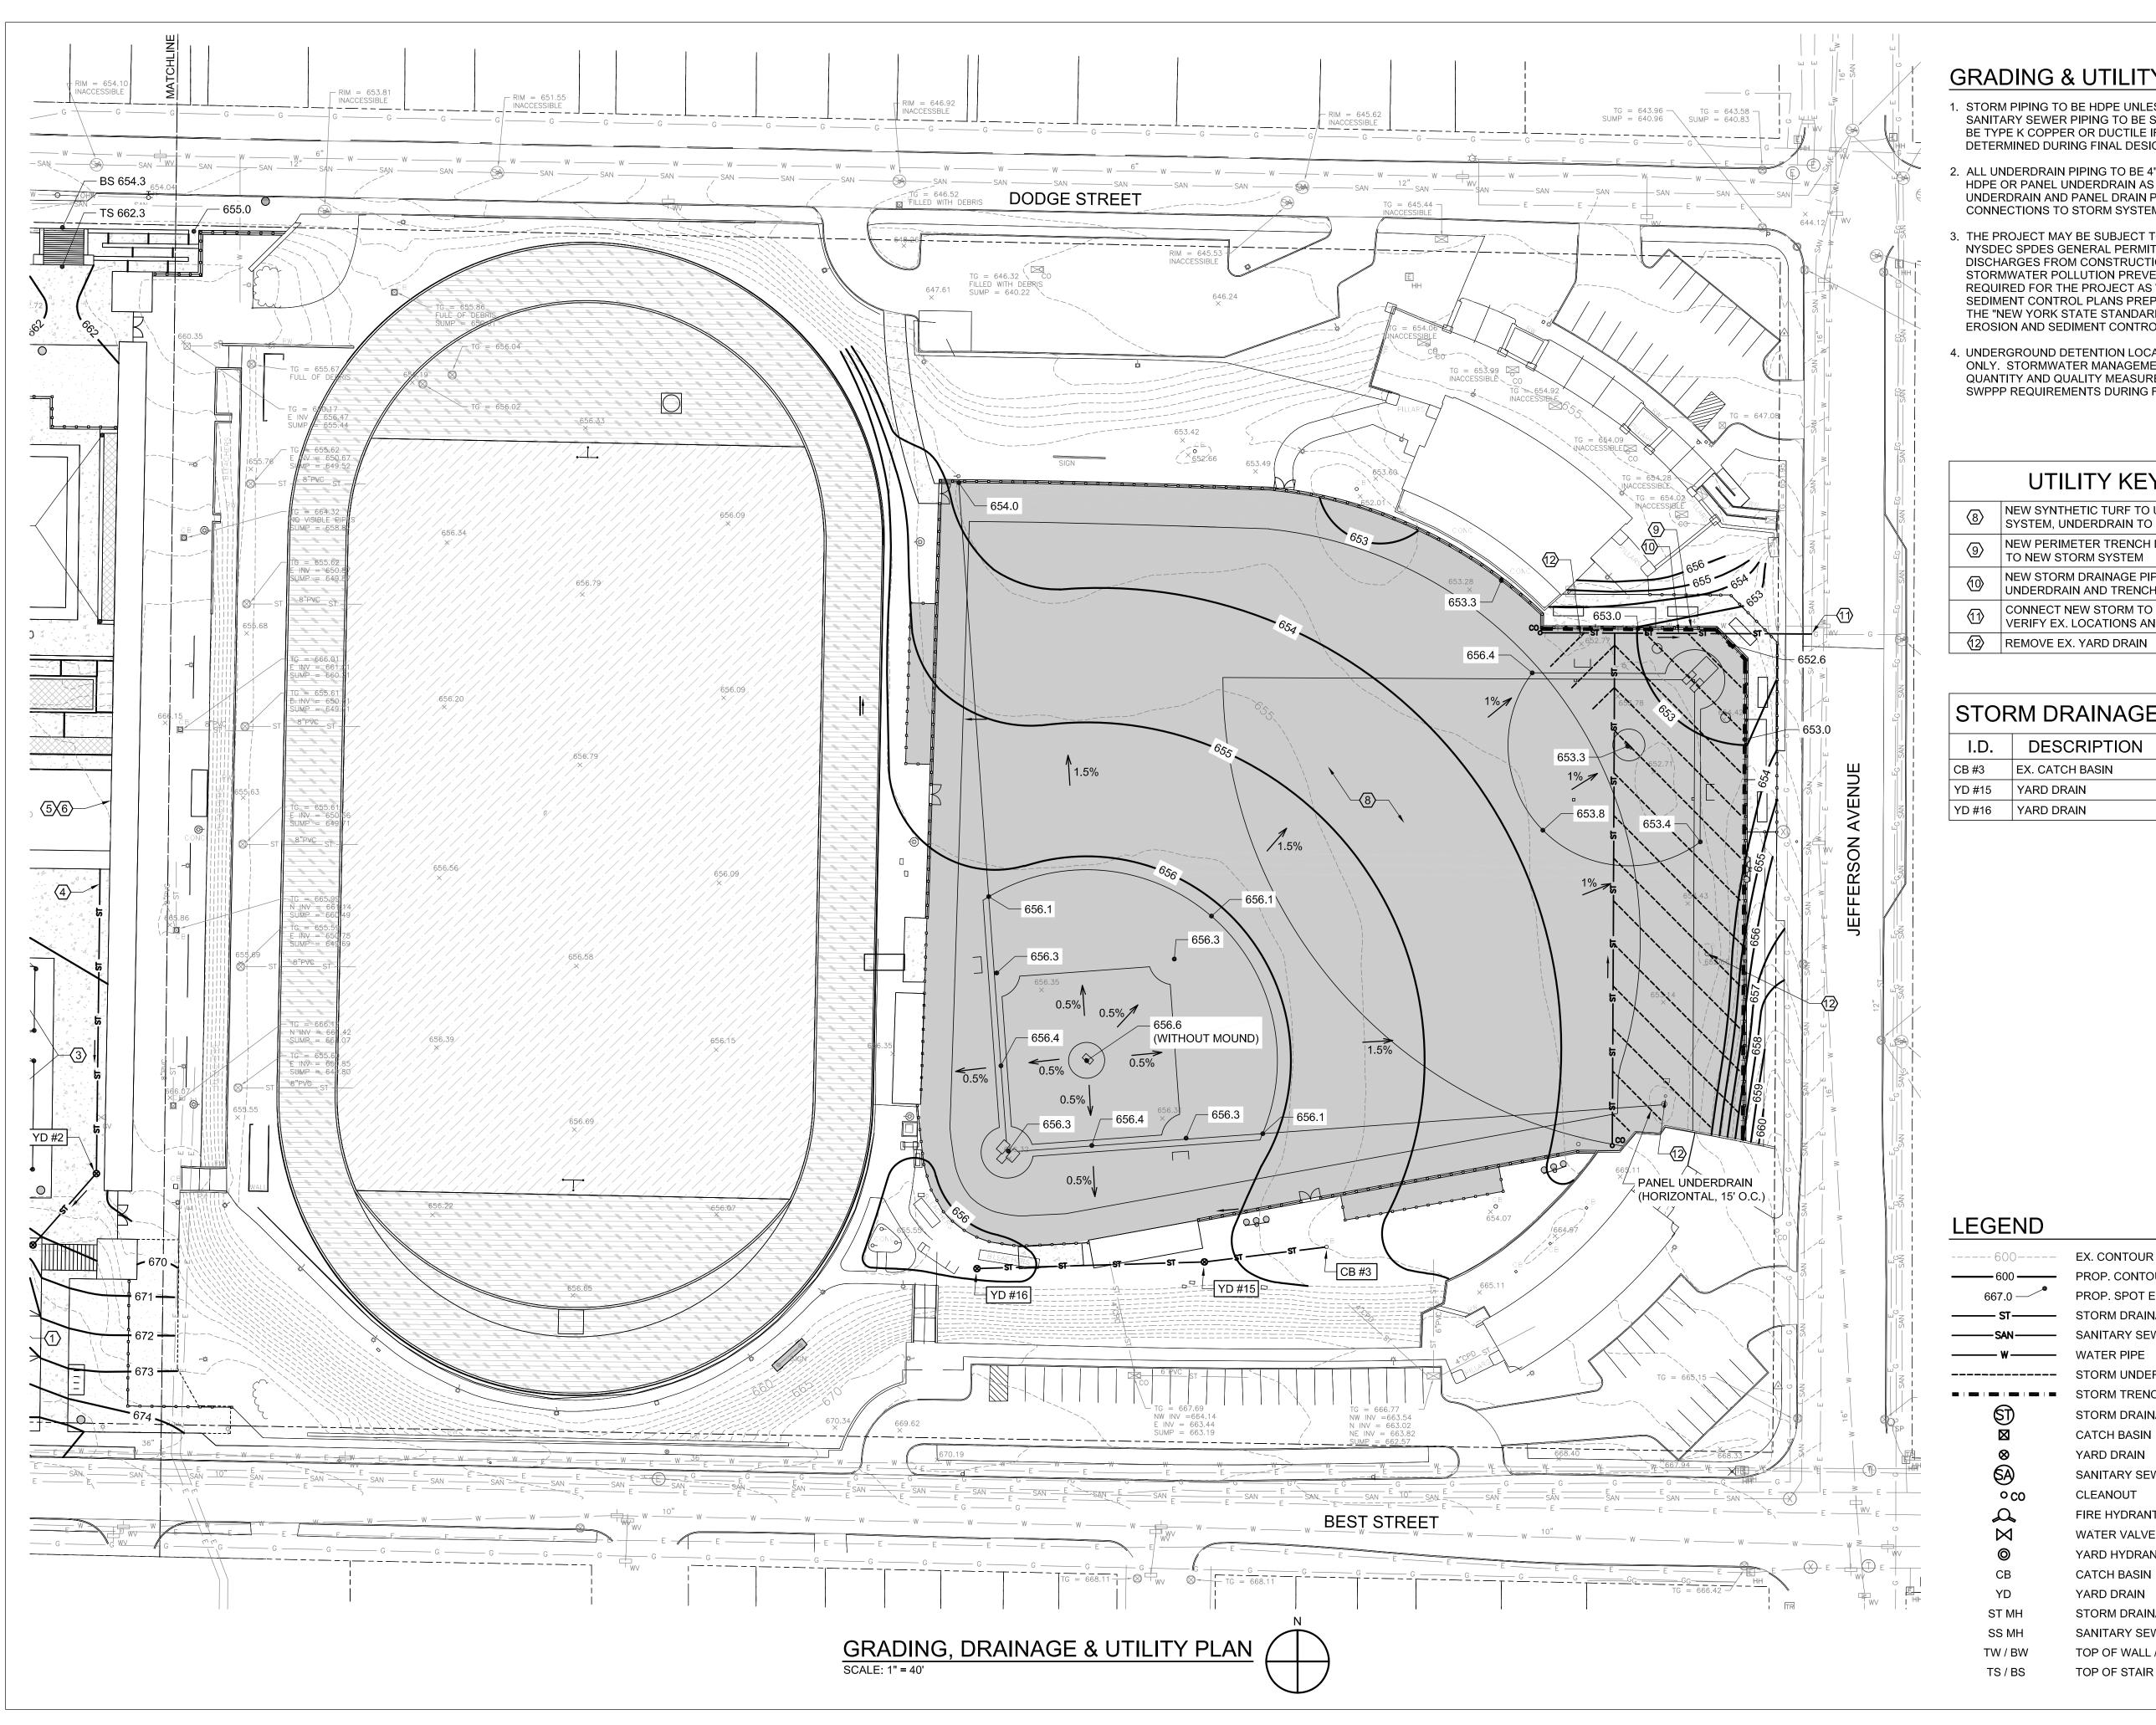
Revisions

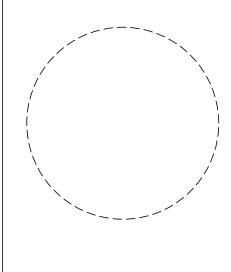City of Buffalo Parks & Buffalo Public School Facilities Survey & Design Development SWBR Project Number 18630.00

Community Foundation for Greater Buffalo 726 Exchange Street, Suite 525 Buffalo, NY 14210

C-101
JBW / Masten

Grading, Drainage & Utility Plan (West)



#### GRADING & UTILITY NOTES

- STORM PIPING TO BE HDPE UNLESS OTHERWISE INDICATED. SANITARY SEWER PIPING TO BE SDR-35 PVC. WATER PIPING TO BE TYPE K COPPER OR DUCTILE IRON. PIPE SIZING TO BE DETERMINED DURING FINAL DESIGN.
- 2. ALL UNDERDRAIN PIPING TO BE 4" DIAMETER PERFORATED HDPE OR PANEL UNDERDRAIN AS INDICATED ON PLANS. UNDERDRAIN AND PANEL DRAIN PIPE TO SLOPE TOWARD CONNECTIONS TO STORM SYSTEM.
- 3. THE PROJECT MAY BE SUBJECT TO THE REQUIREMENTS OF NYSDEC SPDES GENERAL PERMIT FOR STORMWATER DISCHARGES FROM CONSTRUCTION ACTIVITY, GP-0-15-002. A STORMWATER POLLUTION PREVENTION PLAN (SWPPP) IS REQUIRED FOR THE PROJECT AS WELL AS EROSION AND SEDIMENT CONTROL PLANS PREPARED IN ACCORDANCE WITH THE "NEW YORK STATE STANDARDS AND SPECIFICATIONS FOR **EROSION AND SEDIMENT CONTROL."**
- 4. UNDERGROUND DETENTION LOCATION AND SIZE IS SCHEMATIC ONLY. STORMWATER MANAGEMENT SYSTEM (WATER QUANTITY AND QUALITY MEASURES) TO BE DESIGNED TO MEET SWPPP REQUIREMENTS DURING FINAL DESIGN.

#### **UTILITY KEY NOTES**

8	NEW SYNTHETIC TURF TO UTILIZE EX. UNDERDRAIN SYSTEM, UNDERDRAIN TO BE FLUSHED PRIOR TO USE
9	NEW PERIMETER TRENCH DRAIN, CONNECT AND SLOPE TO NEW STORM SYSTEM
10	NEW STORM DRAINAGE PIPING TO COLLECT UNDERDRAIN AND TRENCH DRAIN FLOW
11)	CONNECT NEW STORM TO EX. STORM OR SEWER, VERIFY EX. LOCATIONS AND ELEVATIONS IN THE FIELD

#### STORM DRAINAGE STRUCTURES

I.D.	DESCRIPTION	RIM	INVERT
CB #3	EX. CATCH BASIN	ADJUST 655.2	651.0
YD #15	YARD DRAIN	656.1	651.5
YD #16	YARD DRAIN	655.5	652.5

000	LA. OOMTOOK
<del></del> 600 <del></del>	PROP. CONTOUR
667.0	PROP. SPOT ELEVATION
ST	STORM DRAINAGE PIPE
SAN	SANITARY SEWER PIPE
—— w——	WATER PIPE
	STORM UNDERDRAIN OR PANEL DRAIN
	STORM TRENCH DRAIN
$\mathfrak{S}$	STORM DRAINAGE MANHOLE
	CATCH BASIN
8	YARD DRAIN
<b>S</b> A	SANITARY SEWER MANHOLE
° co	CLEANOUT
$\Delta$	FIRE HYDRANT
$\bowtie$	WATER VALVE
0	YARD HYDRANT
СВ	CATCH BASIN
YD	YARD DRAIN
ST MH	STORM DRAINAGE MANHOLE
SS MH	SANITARY SEWER MANHOLE
TW / BW	TOP OF WALL / BOTTOM OF WALL
TS / BS	TOP OF STAIR / BOTTOM OF STAIR



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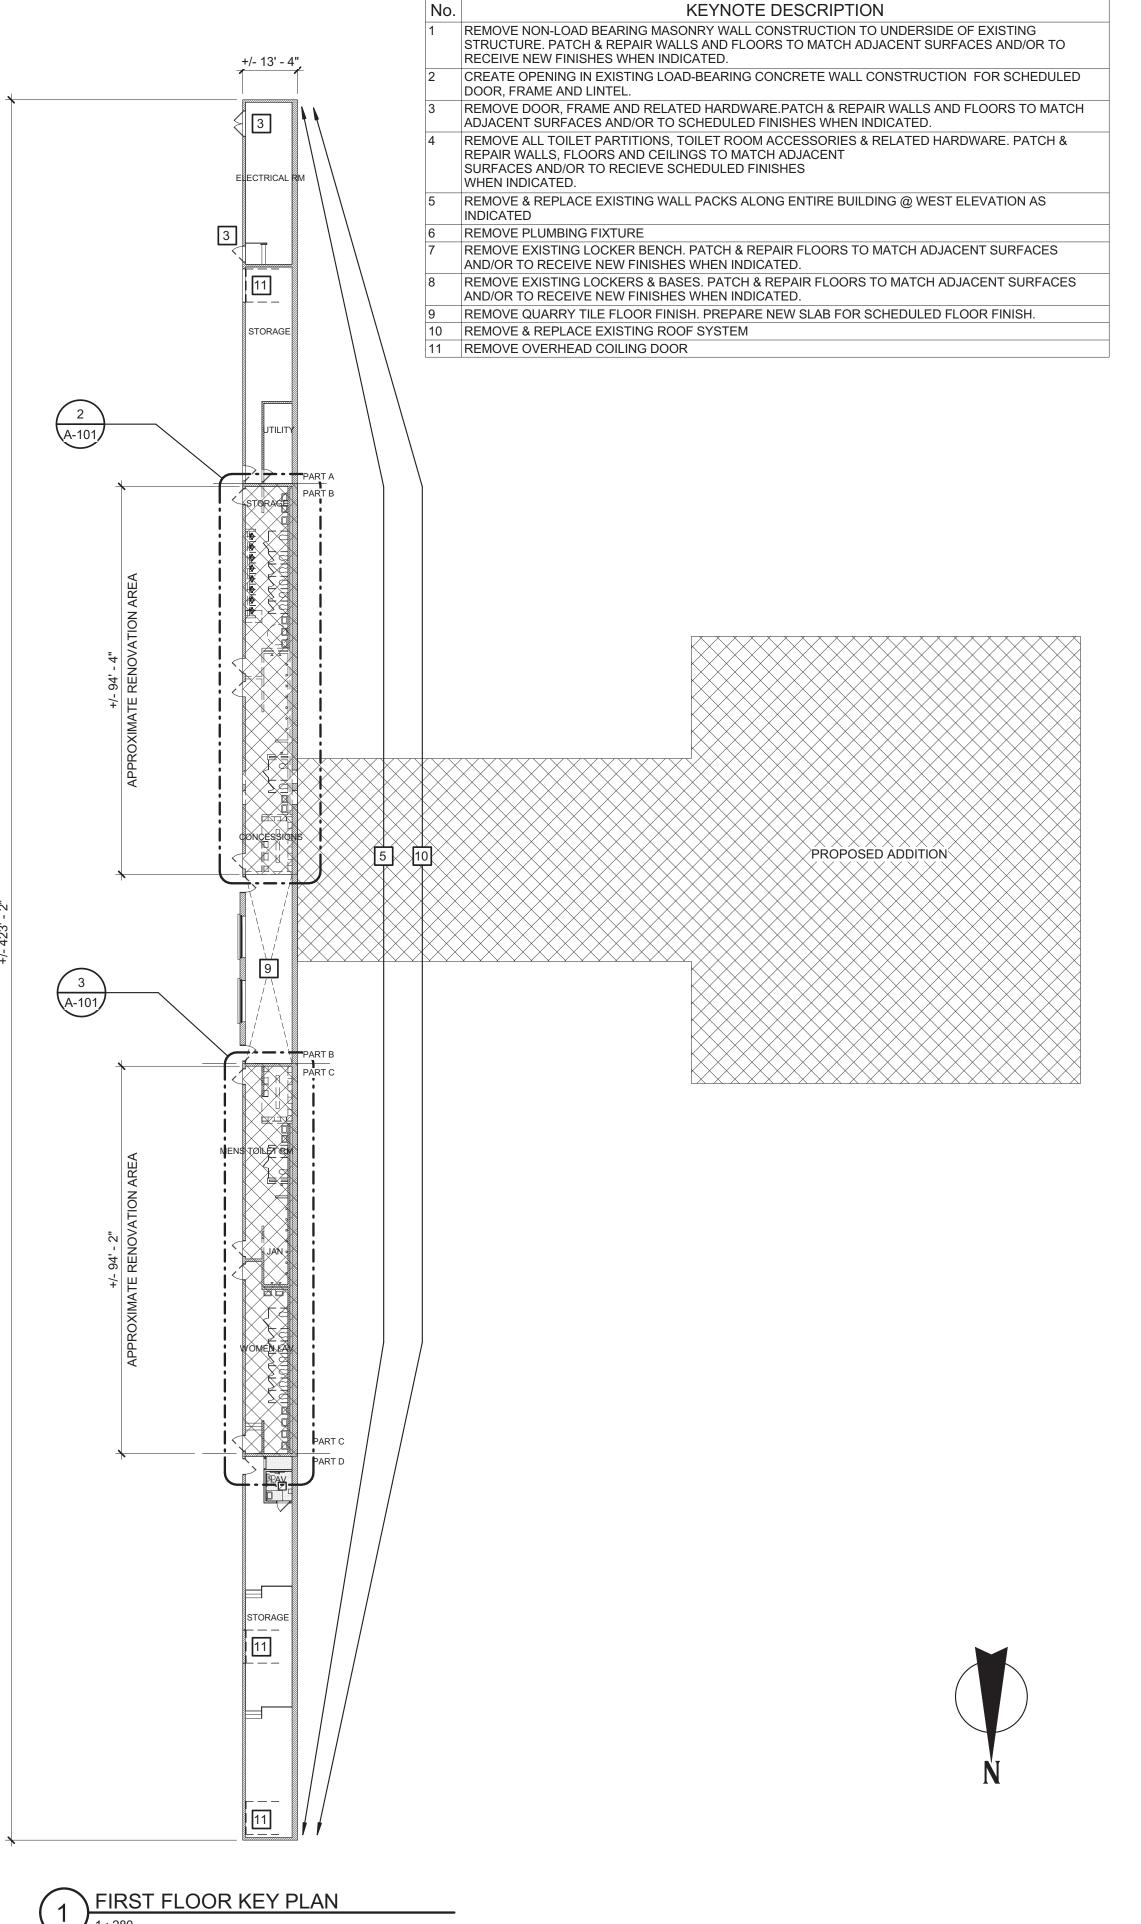
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SWBR Project Number 18630.00 Community Foundation for


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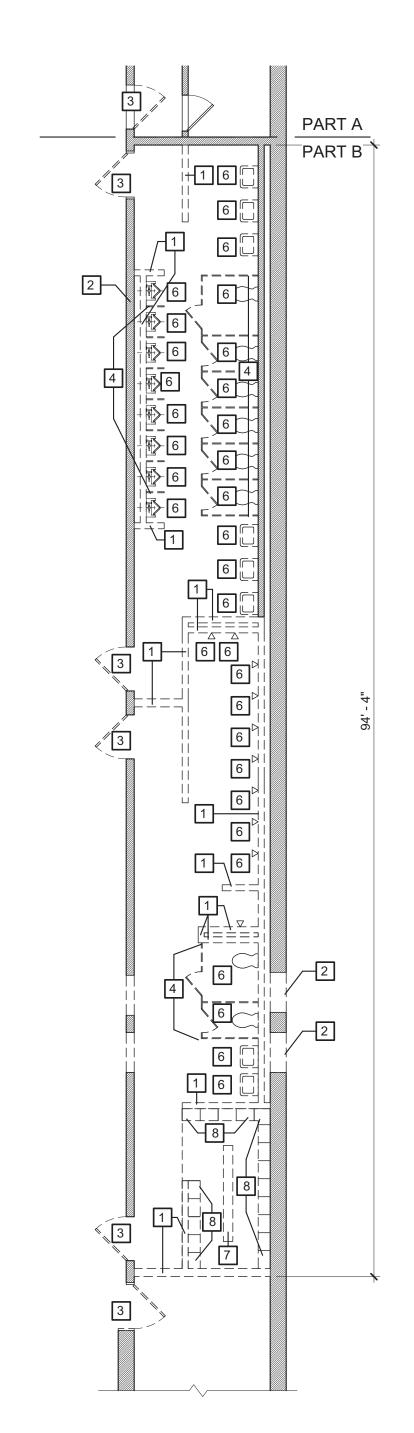
C-102 JBW / Masten

Grading, Drainage & Utility Plan (East)



SERVICE BUILDING - DEMOLITION KEYNOTES



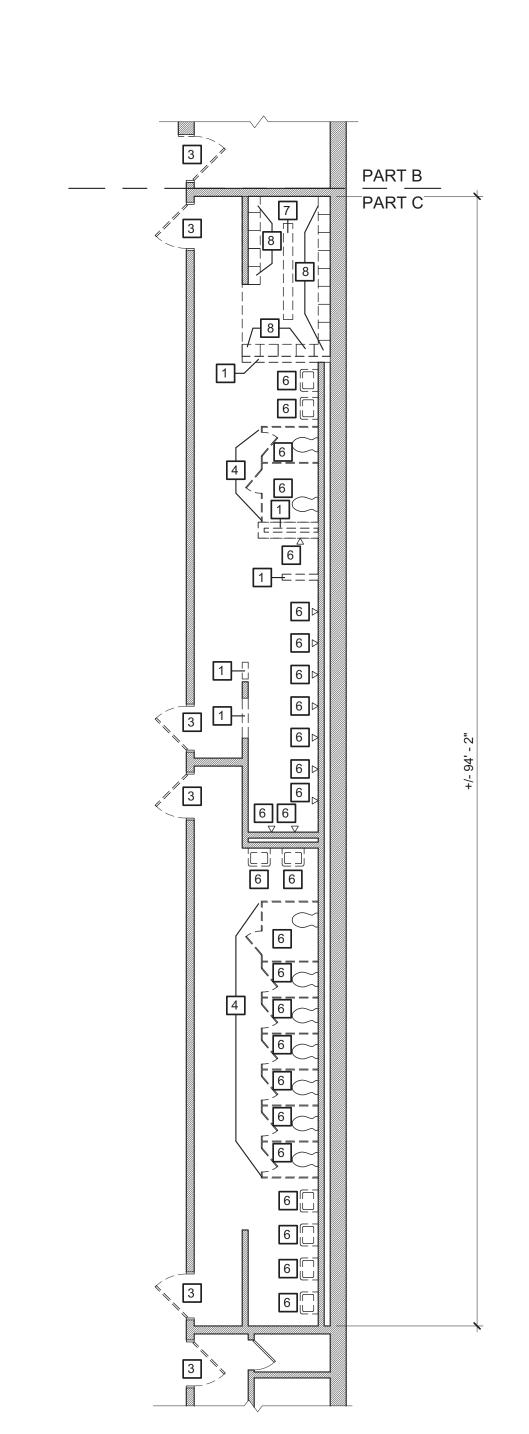

ENLARGED FIRST FLOOR DEMOLITION PLAN

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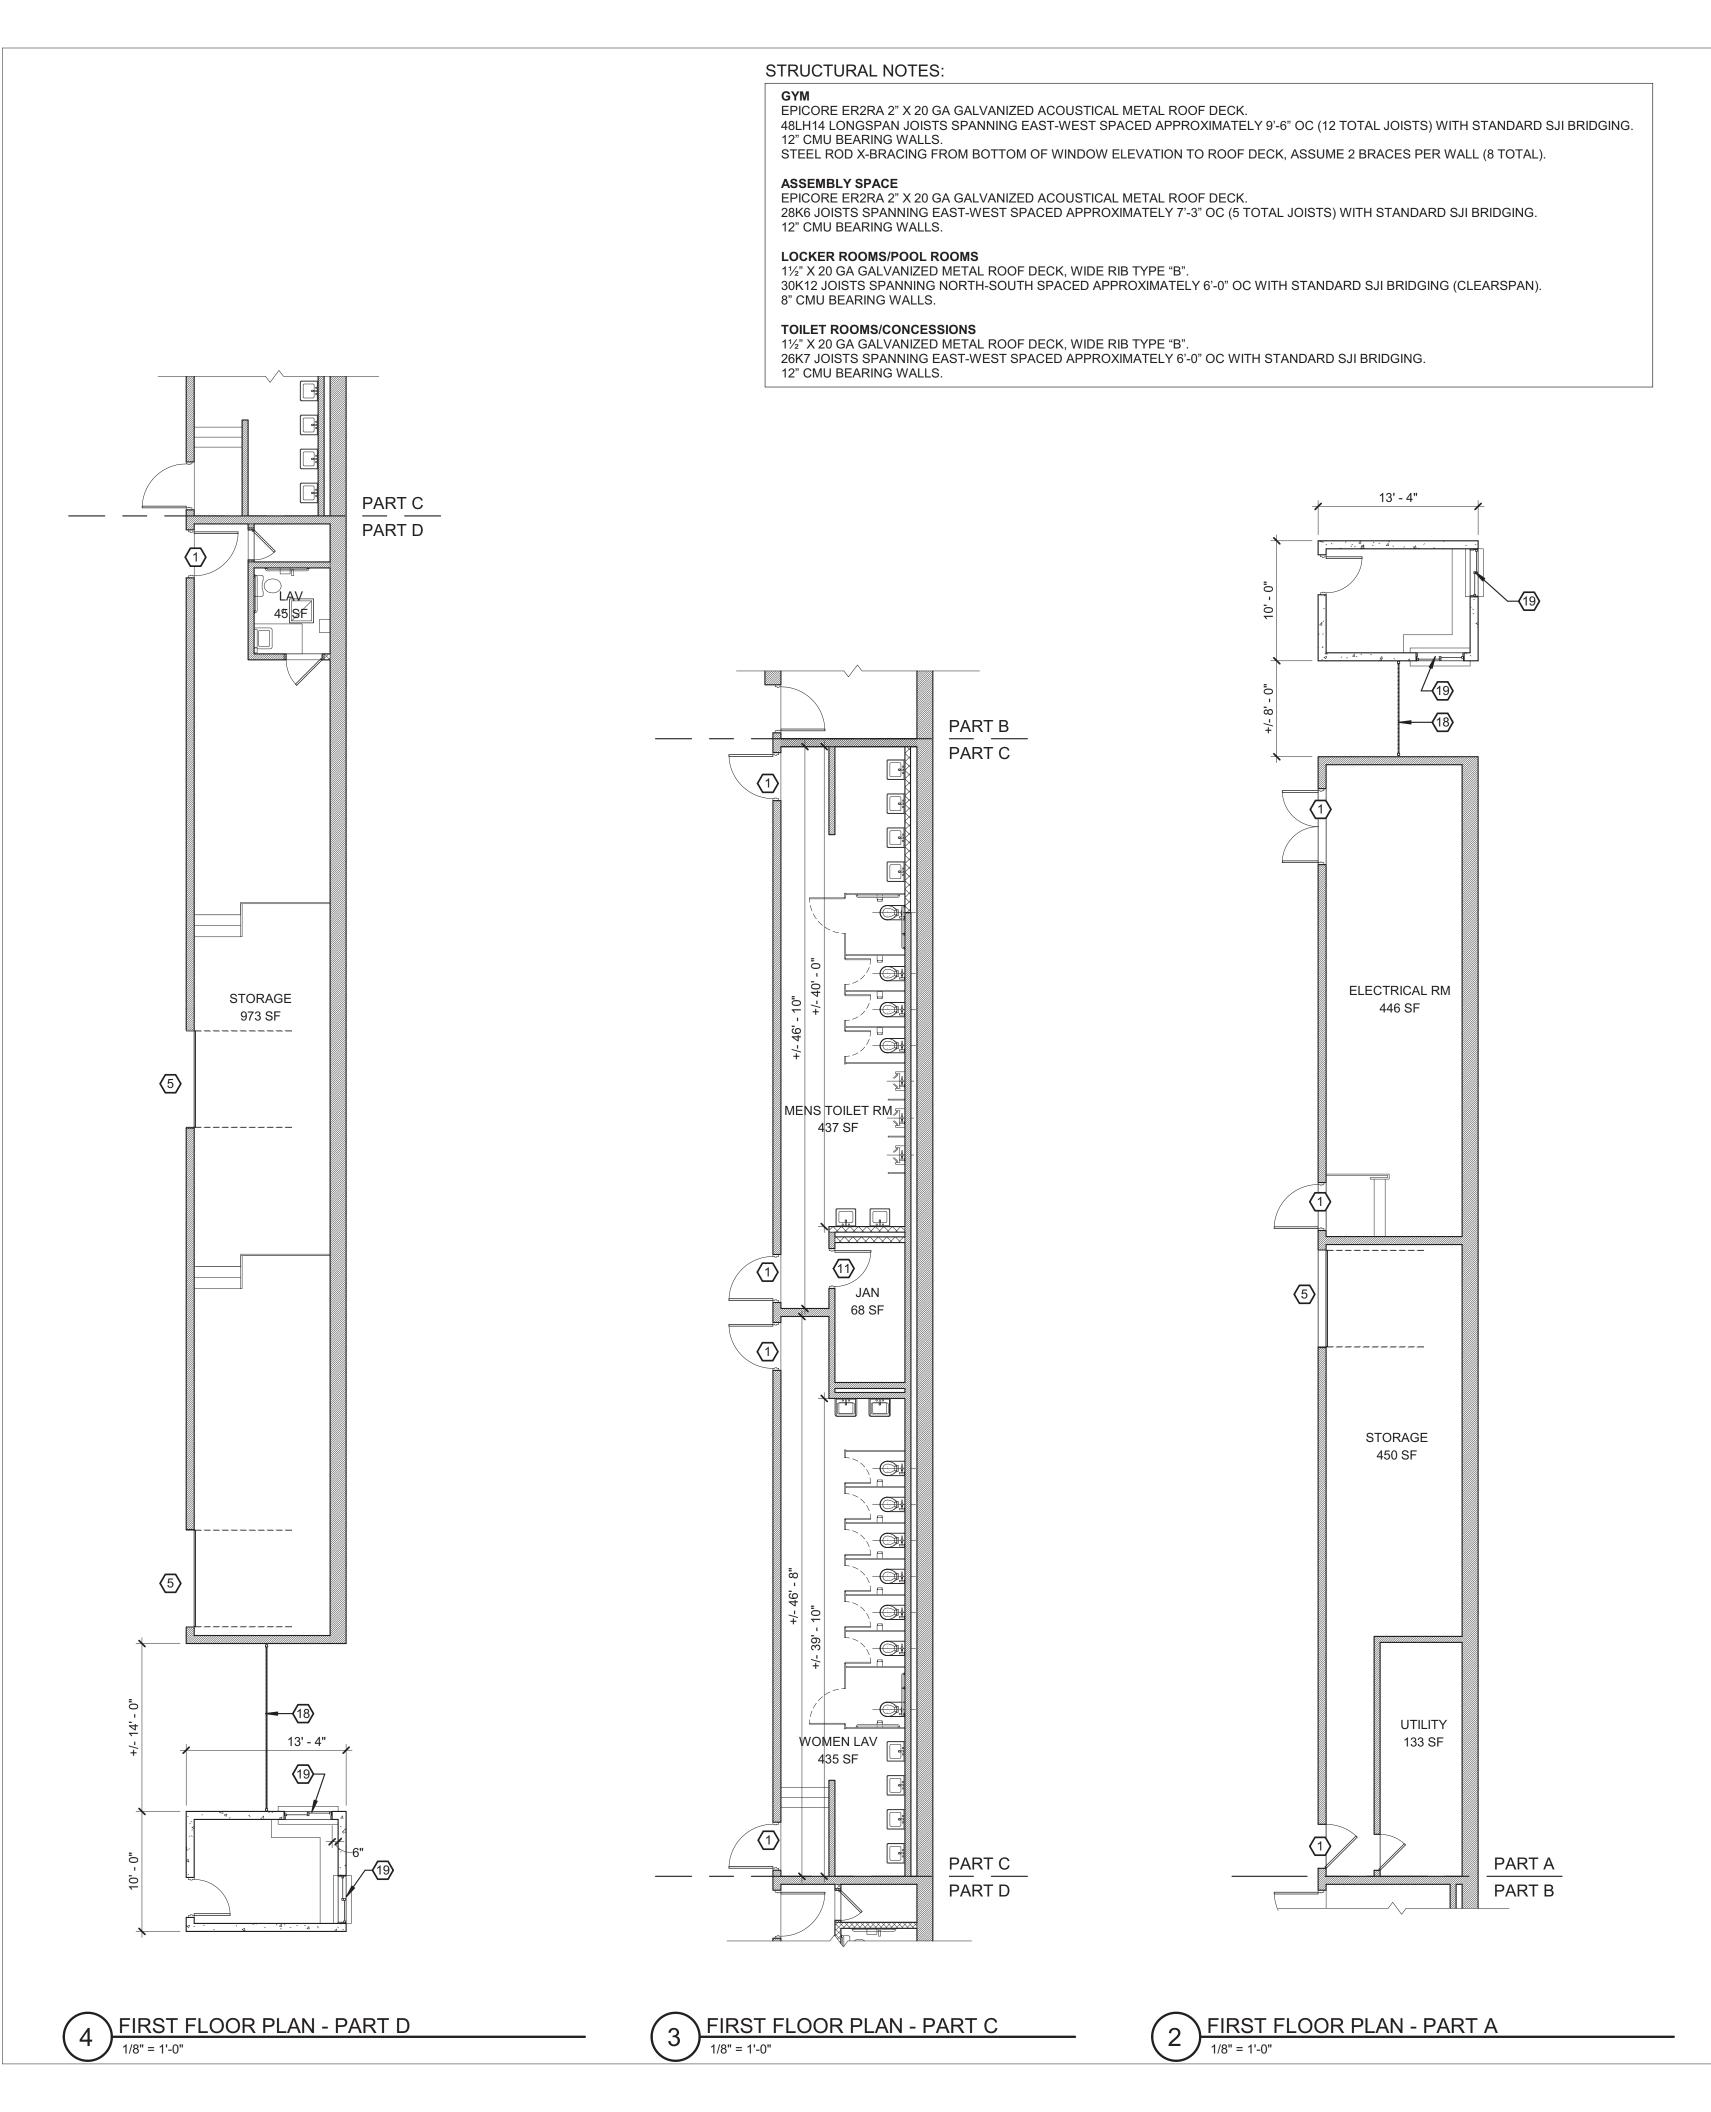
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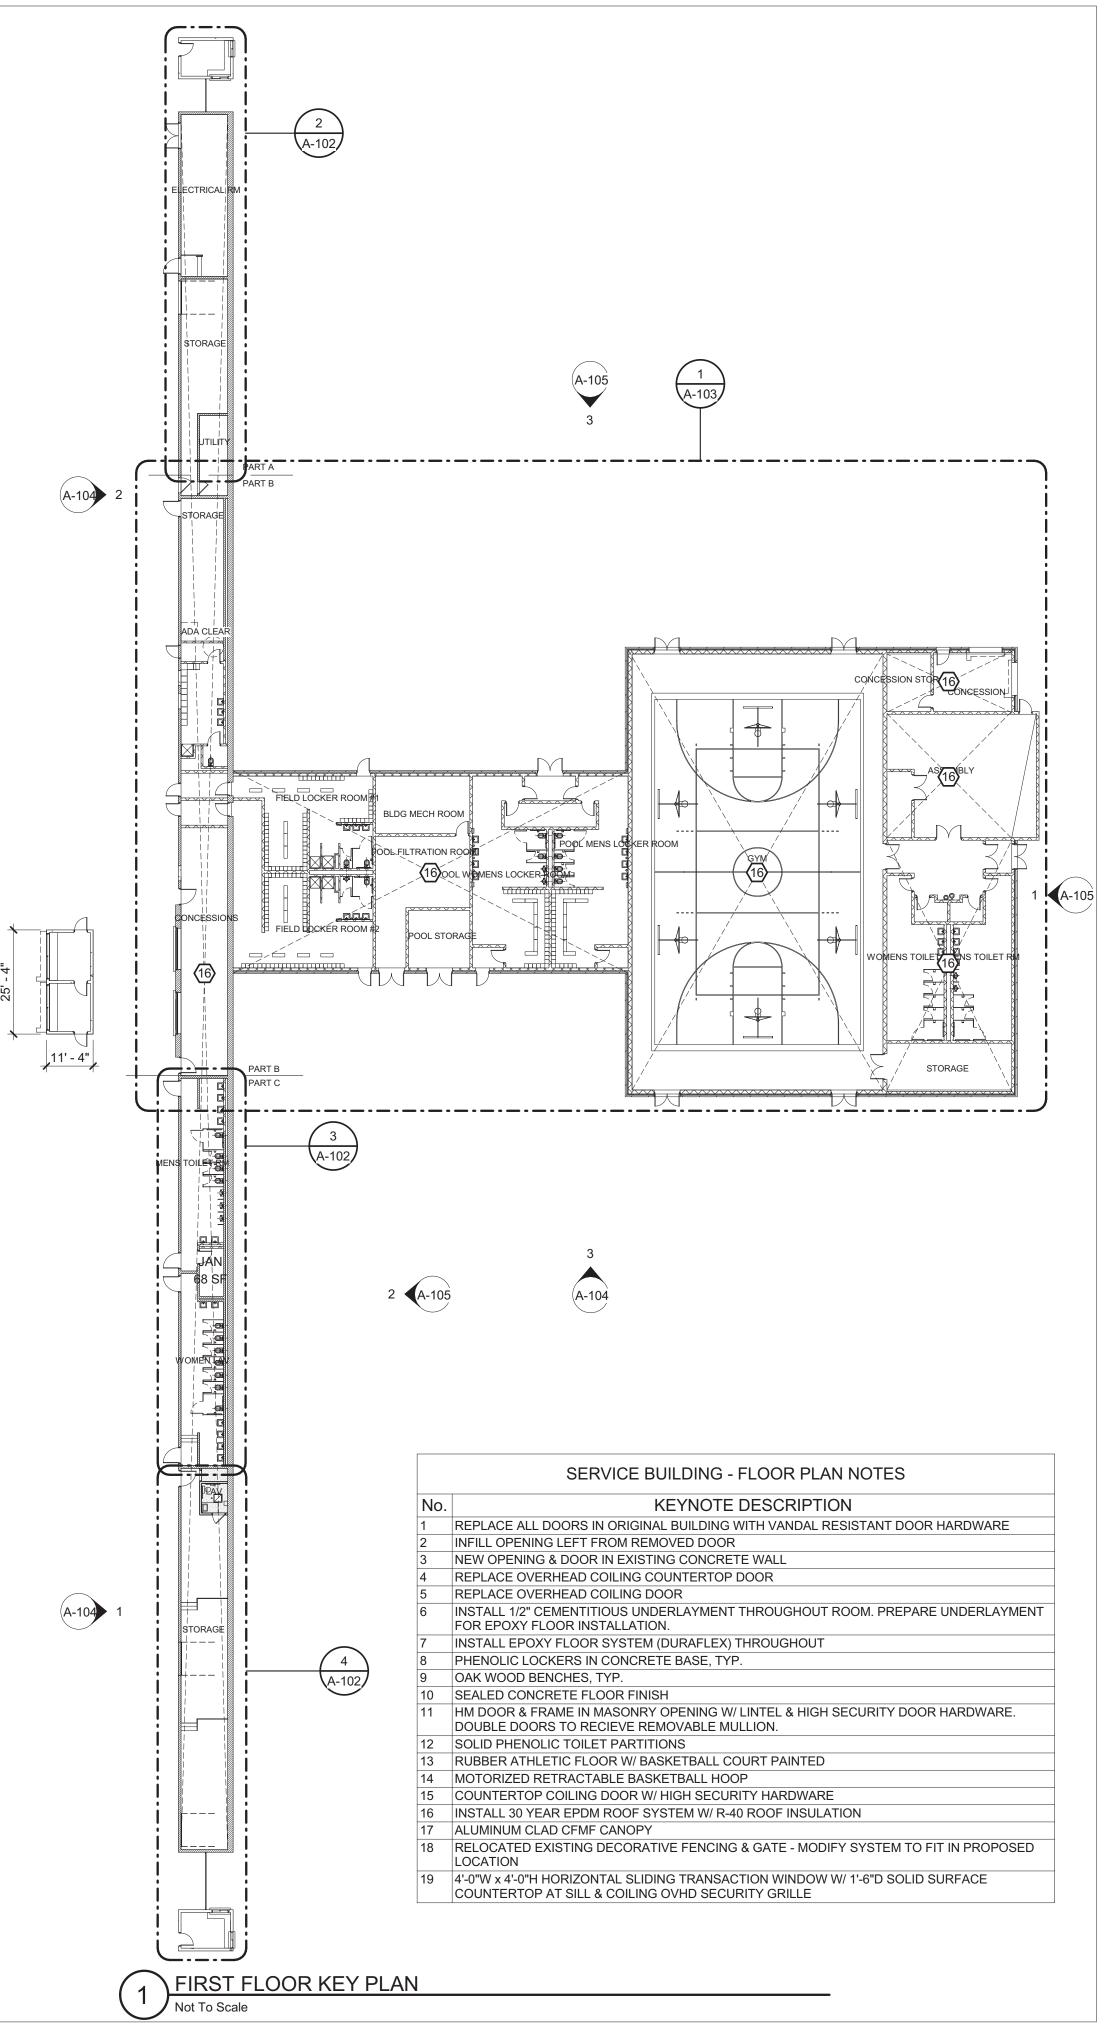
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A-101 JBW/MASTEN

Service Building - First Floor Demolition Plan





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Checked By: DP

Project Manager: DP

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Revisions


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A-102 JBW/MASTEN

Service Building - Key Plan & First Floor Plans



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1 (A-105)

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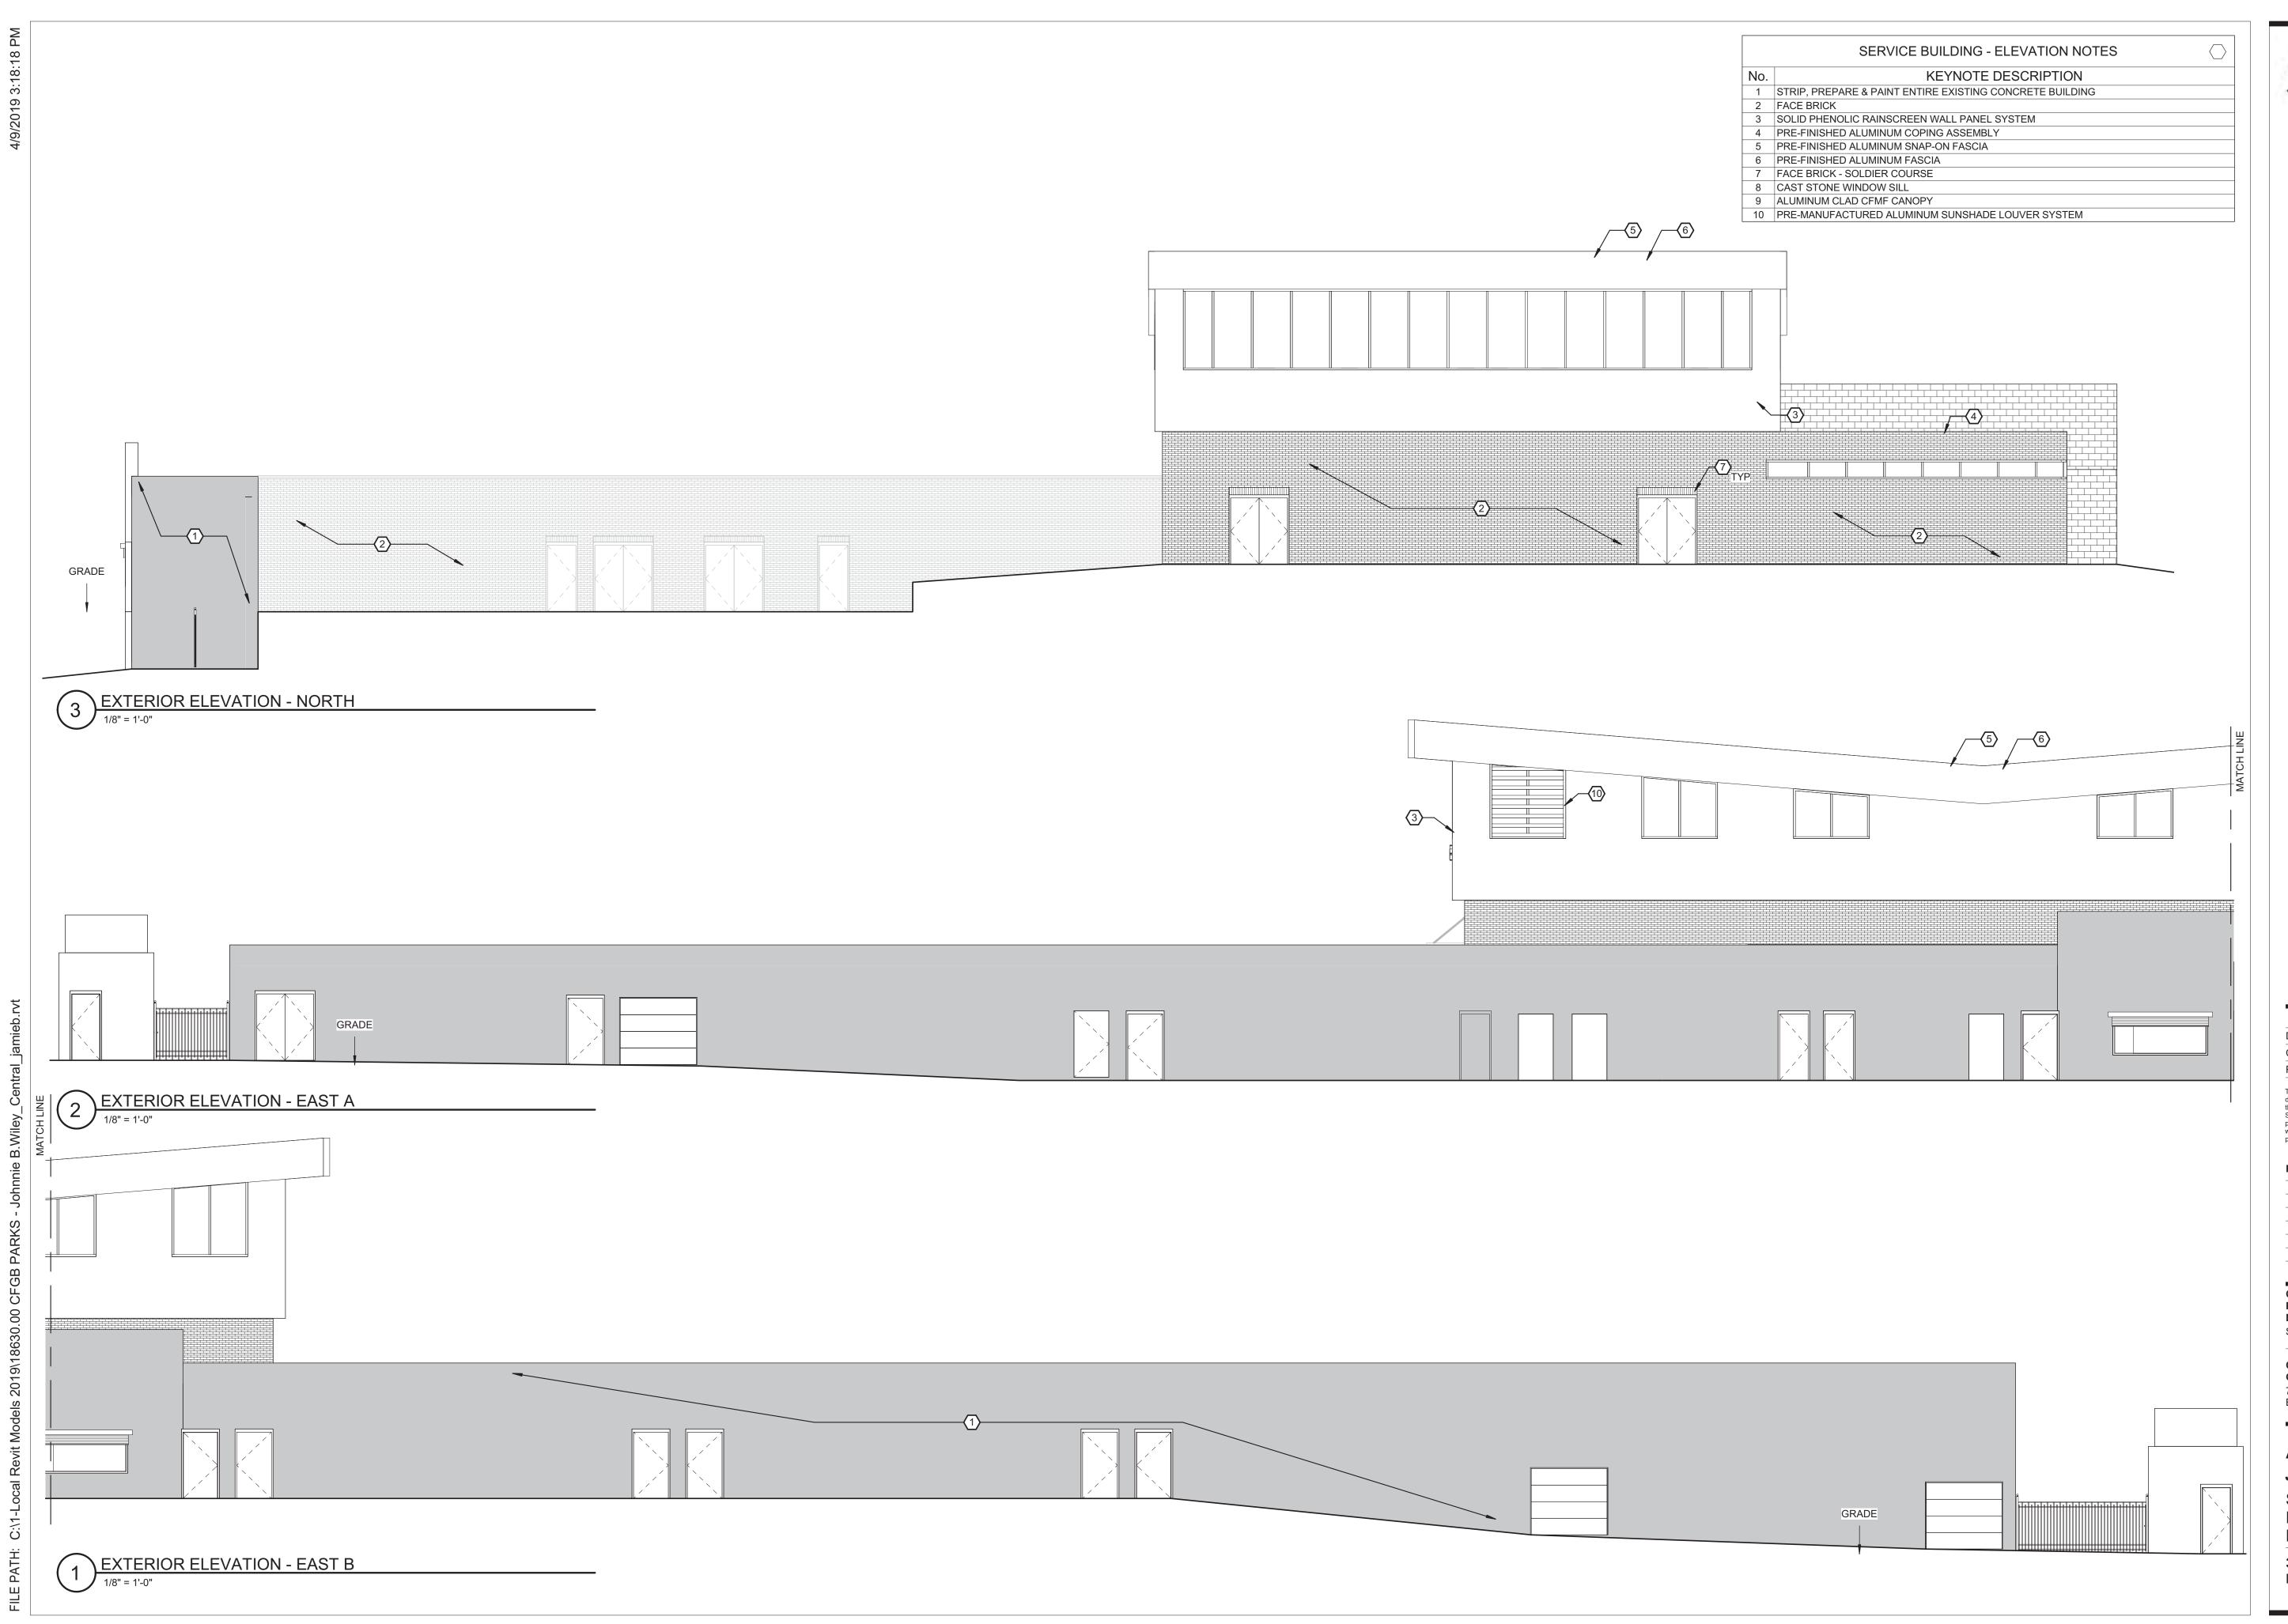
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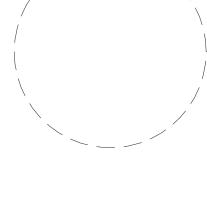
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A-103

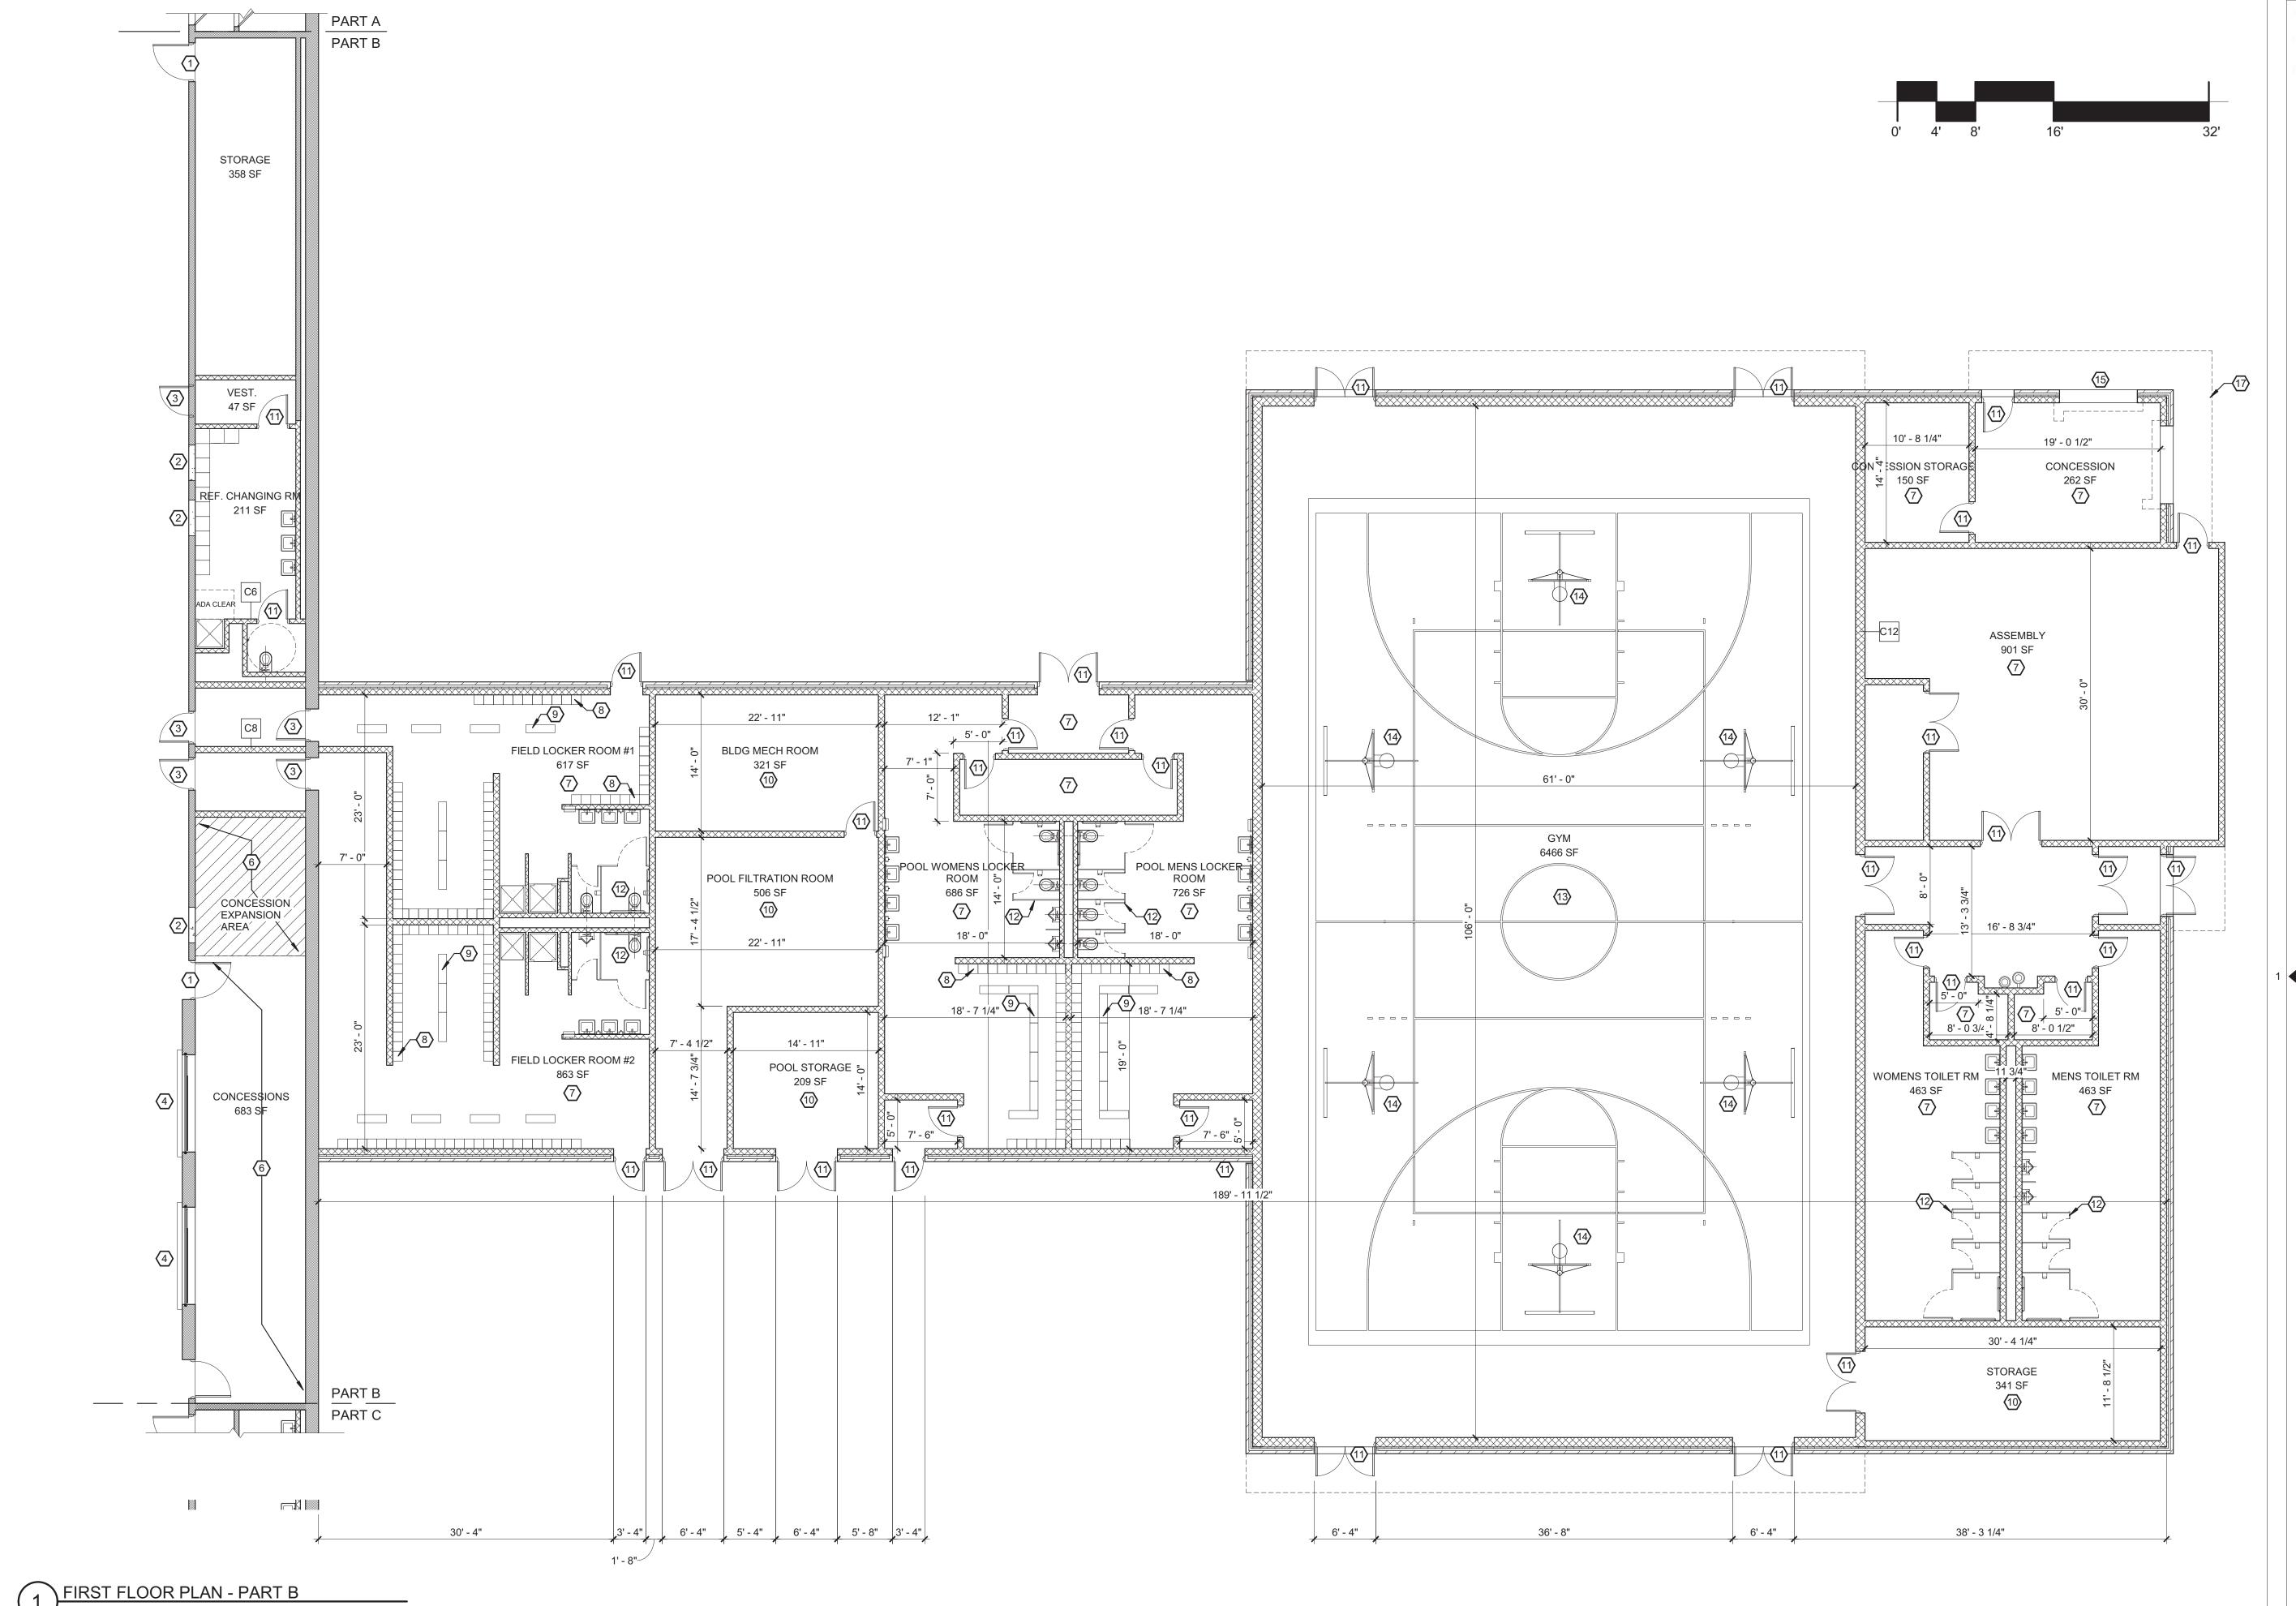JBW/MASTEN
Service Building - First
Floor Plan - Part B



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Drawn By: MDB
Checked By: DP
Project Manager: DP

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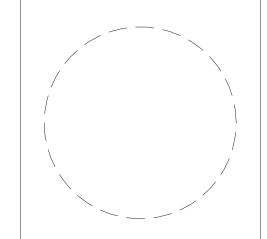
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A-104
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Service Building -Exterior Elevations North & East

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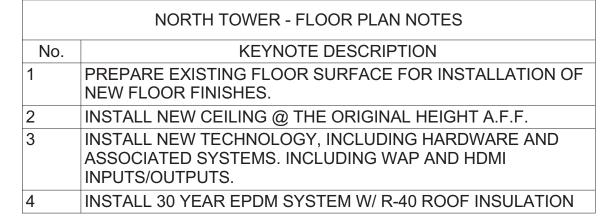
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A-105 JBW/MASTEN

Service Building -Exterior Elevations South & West



STAIR 'B' ENTRY VESTIBULE 106 LOBBY 102 1 2 STAIR 'A'
3 103 12 OFFICE 1 2 OFFICE 1 2 MECH RM TRAINING RM MEN'S RESTROOM WOMEN'S RESTROOM 3 1/2 CONFERENCE RM. (1)(2) (3) LUNCH RM OFFICE 1 2 3

NORTH TOWER - DEMOLITION KEYNOTES **DEMOLITION KEYNOTES** No. REMOVE EXISTING FLOOR FINISH. REMOVE EXISTING CEILING. REMOVE EXISTING AND PERMANENTLY AFFIXED TECHNOLOGY THROUGHOUT IN PREPARATION OF INSTALLING NEW TECHNOLOGY AND ASSOCIATED SYSTEMS. REMOVE & REPLACE EXISTING ROOF SYSTEM



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A-106 JBW/MASTEN

North Tower -Demolition & New Work Plans

3.29.2019 Design Development

NORTH TOWER - FIRST FLOOR DEMOLITION PLAN

NORTH TOWER - FIRST FLOOR PLAN

1/8" = 1'-0"

SOUTH TOWER - DEMOLITION KEYNOTES


REMOVE EXISTING SECURITY ROLLING DOORS

REMOVE & REPLACE EXISTING ROOF SYSTEM

SCHEDULED FINISHES WHEN INDICATED.


KEYNOTE DESCRIPTION


REMOVE DOOR, FRAME AND RELATED HARDWARE.PATCH & REPAIR WALLS AND FLOORS TO MATCH ADJACENT SURFACES AND/OR TO

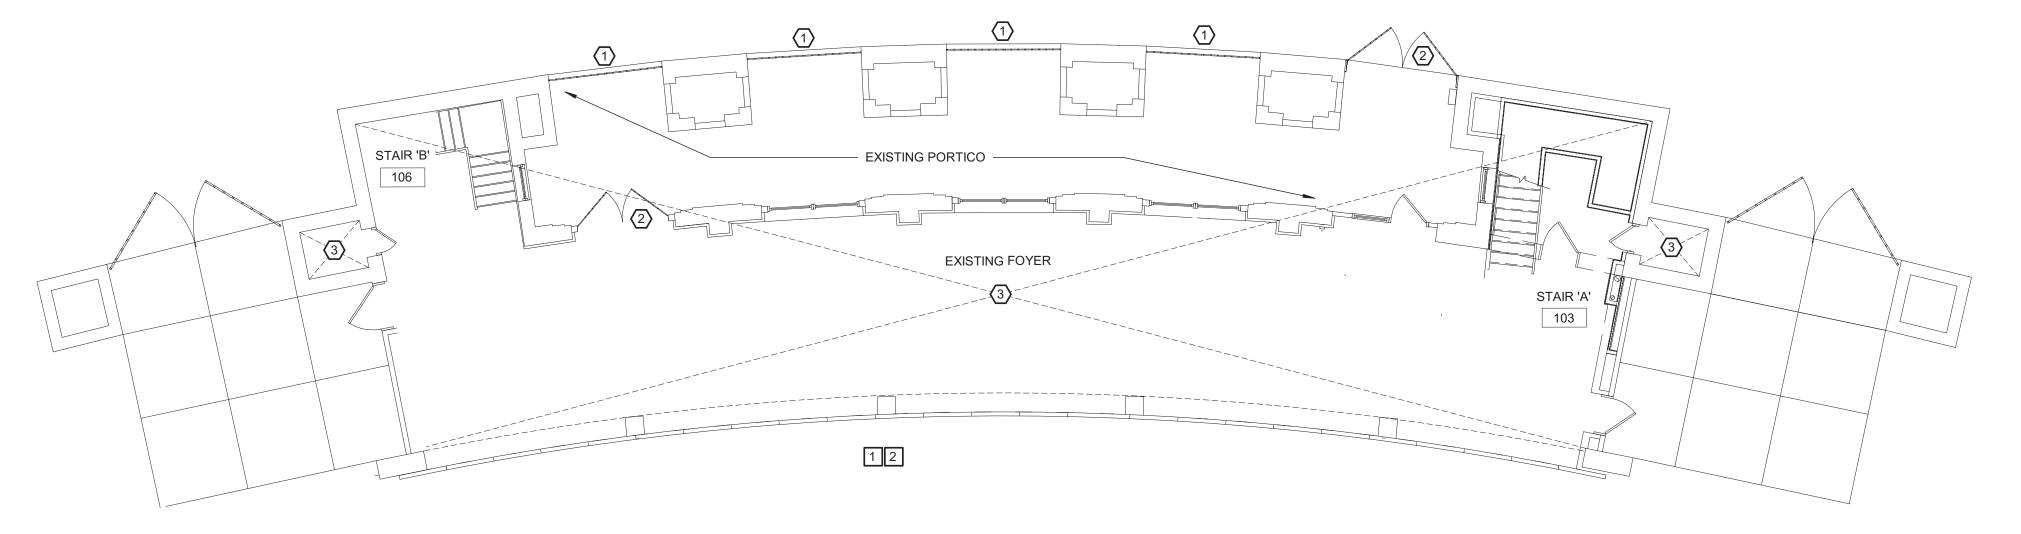

SOUTH TOWER - FIRST FLOOR

1/8" = 1'-0"

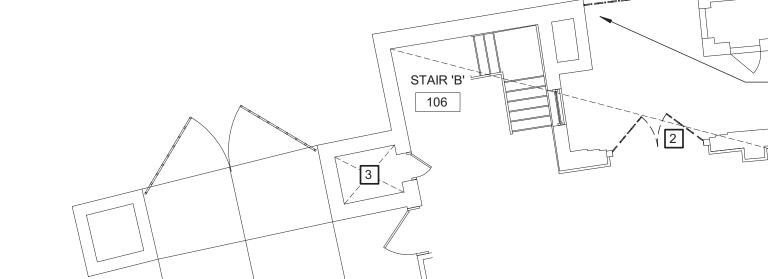

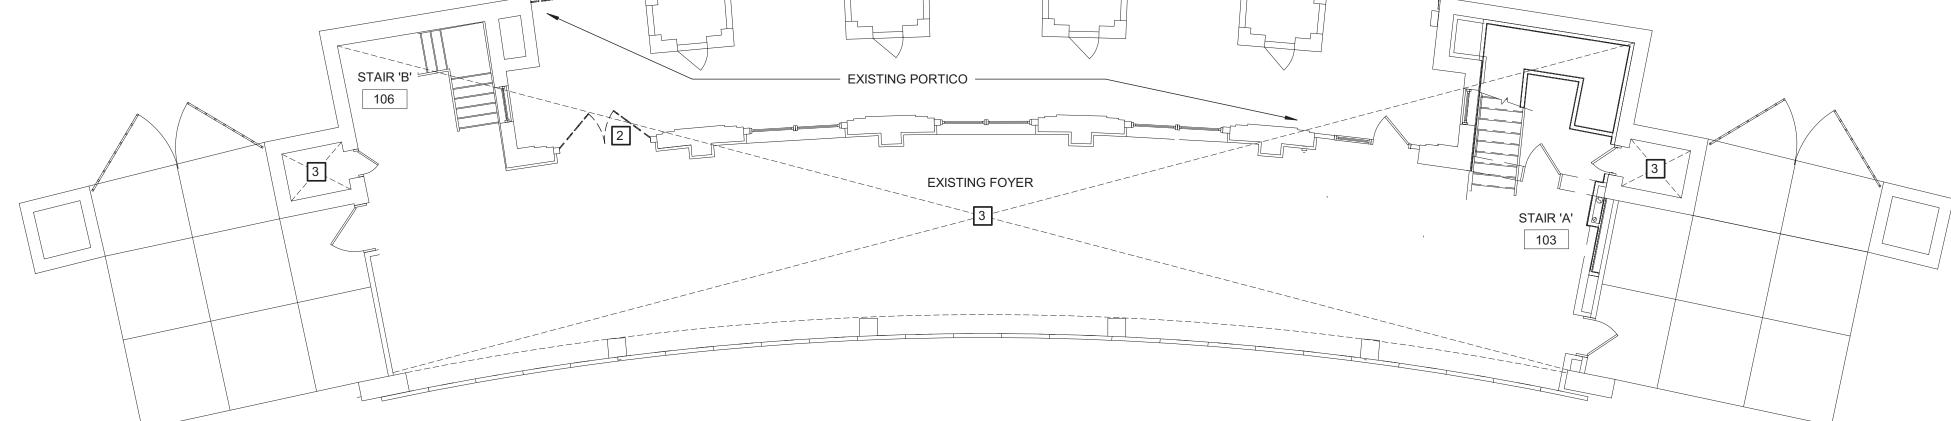


SOUTH TOWER - FIRST FLOOR DEMOLITION PLAN

1/8" = 1'-0"

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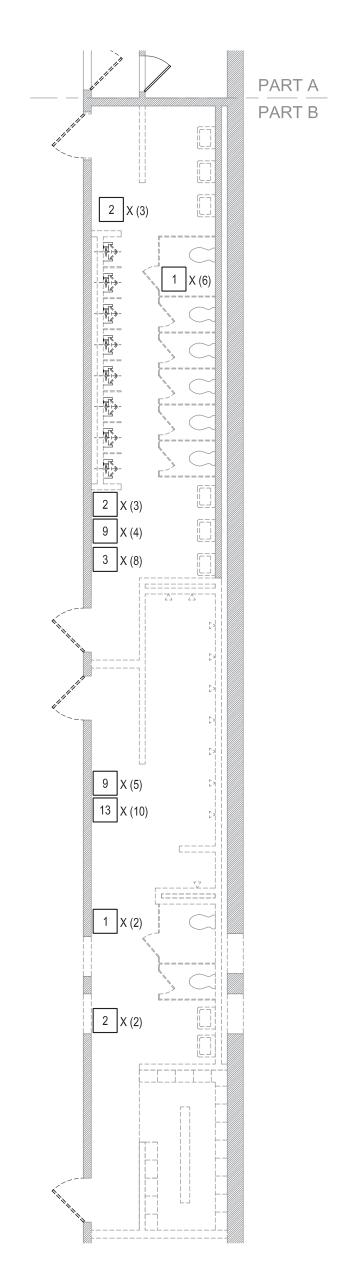
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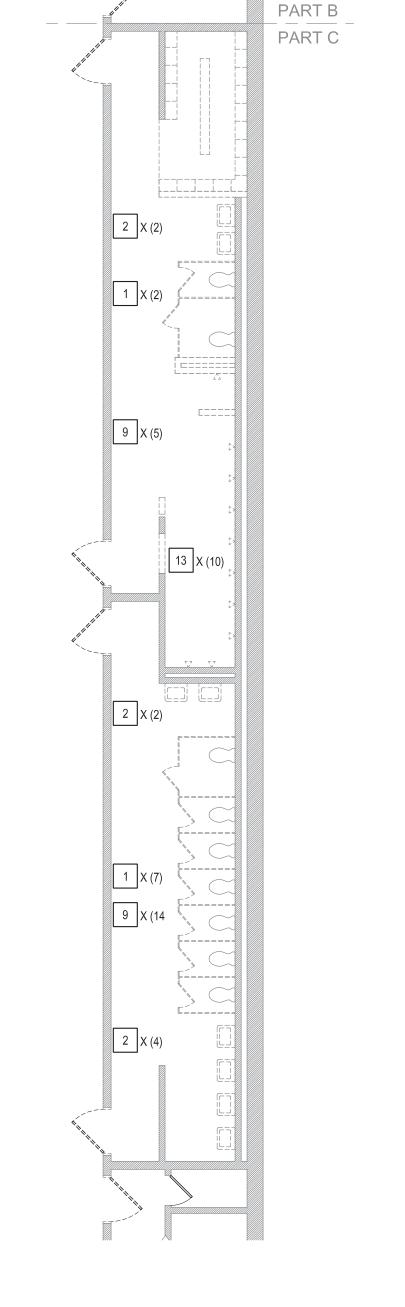
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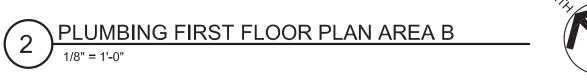
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A-107 JBW/MASTEN

South Tower -Demolition & New Work Plans

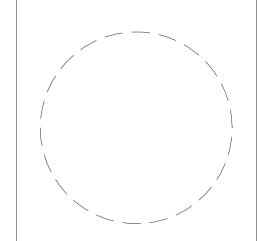









- 1. REMOVE WATER CLOSET, 4" SAN., 2" V. & 1" C. BRANCH PIPING BACK TO MAINS. REMOVE LAVATORY, CARRIER, 1½" SAN., 1½" V. & ½" C. BRANCH PIPING BACK TO MAINS.
- REMOVE URINAL, 2" SAN., 2" V. & ½" C. PIPING BACK TO MAINS.
- 4. REMOVE RPZ AND 2" PIPING BACK TO FLOOR AND CAP 2" C. ABOVE FLOOR.
- REMOVE GREASE TRAP AND 2" SAN. PIPING TO SINK DRAIN.
- 7. EXISTING 3 BASIN STAINLESS STEEL SINK TO REMAIN. REMOVE FAUCETS AND DRAINS.
- DISCONNECT AND REMOVE SINK FROM WALL. 8. REMOVE WATER HEATER.
- 9. REMOVE FLOOR DRAIN AND TRAP.

6. EXISTING 2" G PIPING TO REMAIN.



#### **BUILDINGS TO BE RENOVATED**

WATER AND SANITARY SEWERS: EXCAVATE DOWN AT THE EXTERIOR OF BUILDING AND SAW CUT AND DISCONNECT SANITARY SEWER AND DOMESTIC WATER SERVICE PIPING. SANITARY SEWER AND WATER SERVICE SHALL BE REMOVED OR ABANDONED IN PLACE BELOW GRADE. SERVICES SHALL BE CAPPED OR PLUGGED AT THE ENDS AND MARKED AS "ABANDONED IN PLACE". EXISTING SANITARY SEWERS SHALL BE REMOVED BELOW THE FLOOR SLAB. NEW SCHEDULE 40 SOLID CORE PVC SANITARY SEWERS SHALL BE PROVIDED BELOW THE FLOOR SLAB AND EXTENDED TO THE NEAREST SANITARY SITE MANHOLE. A NEW TYPE L COPPER OR DUCTILE IRON WATER SERVICE SHALL BE EXTENDED FROM THE CITY STREET MAIN TO THE BUILDING. THE WATER SERVICE SHALL ENTER THE BUILDING INSIDE THROUGH THE FOUNDATION WALL AND FLOOR SLAB AND BE LOCATED NEAR AN EXTERIOR WALL. FLOORS WILL BE SAW CUT TO PERMIT THE EXCAVATION REMOVAL AND REPLACEMENT OF EXISTING PIPING BELOW THE FLOOR SLAB. FLOORS WILL REPLACED AND TO MATCH EXISTING SURFACES.

EXISTING WATER METER PITS: METERS INSIDE STRUCTURES BELOW GRADE SHALL BE REMOVED AND A SPOOL PIECE PIPE SECTION WITH INSTALLED IN THE EXISTING PIT IN PLACE OF THE METER SET. AN INVESTIGATION OF THE EXISTING METER SHALL BE CONDUCTED JOINTLY WITH CITY OF BUFFALO PARKS PERSONNEL TO ASSESS IT FOR SALVAGE VALUE FOR REUSE AT OTHER SITES.


GAS SERVICE: COORDINATE WITH NATIONAL FUEL FOR THE REMOVAL OF GAS METER SET. ANY REMOVAL OF BELOW GRADE PIPING SHALL BE AS PER NATIONAL FUELS DISCRETION. A NEW METER SET AND SERVICE SIZED TO MATCH TO ANY WATER HEATING, KITCHEN OR BUILDING HEATING EQUIPMENT INSIDE.

EYEWASHES SHALL BE CONDUCTED JOINTLY WITH CITY OF BUFFALO PARKS PERSONNEL TO ASSESS SALVAGE VALUE FOR REUSE AT OTHER SITES. DISCONNECT AND REMOVE ANY FIXTURES AS REQUESTED BY THE CITY OF BUFFALO PARKS. SALVAGED EQUIPMENT SHALL BE REMOVED BY PARKS PERSONNEL OFF-SITE PRIOR TO THE DEMOLITION OF THE STRUCTURE. NEW PLUMBING FIXTURES INCLUDING WATER CLOSETS, URINALS, LAVATORIES, SINKS, MOP SERVICE SINKS, AND SHOWERS IF REQUIRED WILL BE PROVIDED. PLUMBING SPECIALTIES INCLUDING FLOOR DRAINS, FLOOR CLEANOUTS, GREASE INTERCEPTORS, WATER HAMMER ARRESTORS AND WALLS HYDRANTS WILL BE PROVIDED. ELECTRIC OR GAS WATER HEATERS SIZED TO SERVE THE FIXTURE AND EQUIPMENT LOADS WILL BE PROVIDED. REQUIRED SAFETY DEVICES SUCH AS EYEWASHES WILL BE PROVIDED FOR BUILDINGS INCLUDING KITCHENS OR WATER TREATMENT EQUIPMENT FOR SWIMMING POOLS.

WATER SERVICE ENTRANCE: COORDINATE WITH THE CITY OF BUFFALO PARKS FOR THE DISCONNECTION AND REMOVAL OF THE BUILDING WATER SUPPLY, WATER METER, ANY SUB-METERS AND ALL BACKFLOW PREVENTION DEVICES. THE METERS AND BACKFLOW PREVENTION DEVICES SHALL BE JOINTLY CONDUCTED FOR SALVAGE VALUE AND REUSE AT OTHER SITES BY BUFFALO PARKS PERSONNEL AND THE CONTRACTOR. THE WATER METERS AND BACKFLOW PREVENTION DEVICES SALVAGED SHALL BE REMOVED BY BUFFALO PARKS PERSONNEL OFF-SITE PRIOR TO THE DEMOLITION OF THE STRUCTURE. A NEW METER SET WILL BE LOCATED AS PART OF A NEW WATER SERVICE ENTRANCE IN THE INTERIOR OF THE BUILDING, INSTALLED ADJACENT TO AN EXTERIOR WALL AND FITTED WITH A REDUCED PRESSURE ZONE BACKFLOW DEVICE. A WATER SUPPLY AND METER COMPLYING WITH THE CITY OF BUFFALO DIVISION OF WATER REQUIREMENTS WILL BE PROVIDED. A REDUCED PRESSURE ZONE BACKFLOW PREVENTION DEVICE WILL BE PROVIDED DOWNSTREAM OF THE METER ON THE DOMESTIC WATER SERVICE AND IN

ELECTRIC, WATER SERVICE, DOMESTIC WATER BACKFLOW PREVENTION AND SANITARY SEWER SYSTEMS. APPLICATIONS AND DESIGN SUBMISSIONS MUST INCLUDE CAPACITIES AND DEMONSTRATION OF CODE COMPLIANCES. APPLICATIONS INCLUDE THE ADDED DISCHARGE CAPACITY TO THE CITY SANITARY SEWER SYSTEM, WATER SERVICES AND GAS INCLUDE DESIGN SUBMISSIONS FOR APPROVAL, TAPPING PERMITS BY CONTRACTORS


THE CONTRACTOR SHALL PROVIDE FOR THE COORDINATION AND THE TIMING OF UTILITY REMOVALS AND REPLACEMENTS WITH UTILITY AGENCIES. THE CONTRACTOR SHALL PROVIDE FOR CONTACT, APPLICATION AND ALL COST ASSOCIATED WITH REMOVAL WORK AND COMPLETE THE WORK IN COMPLIANCE WITH EACH AGENCIES WRITTEN REQUIREMENTS. CONTACTS SHALL INCLUDE THE BUFFALO DIVISION OF WATER, BUFFALO SEWER AUTHORITY AND NATIONAL FUEL.

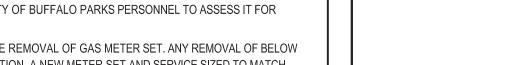

ANY BUILDING EQUIPMENT LOADS WILL BE PROVIDED BY NATIONAL FUEL. SCHEDULE 40 STEEL GAS PIPE EXTENDED AN INVESTIGATION OF ALL EXISTING PLUMBING FIXTURES, WATER HEATERS AND SAFETY DEVICES SUCH AS

COMPLIANCE WITH THE CITY OF BUFFALO AND NEW YORK STATE HEALTH DEPARTMENT CODE REQUIREMENTS.

APPLICATIONS FOR ALL UTILITY SERVICES WILL BE REQUIRED TO THE RESPECTIVE UTILITIES FOR THE GAS, AND FINAL INSPECTION APPROVALS.

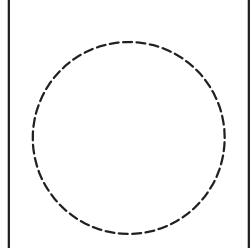

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Checked By:	MJS
Project Manager:	RCP

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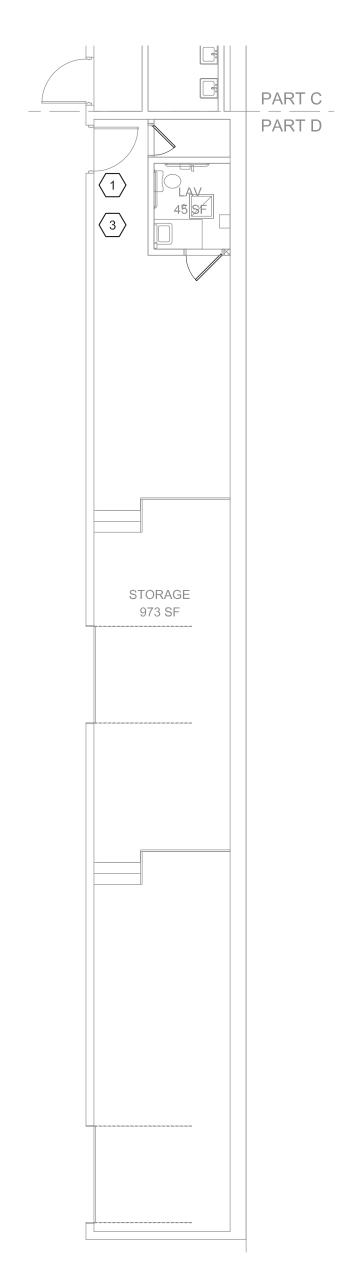
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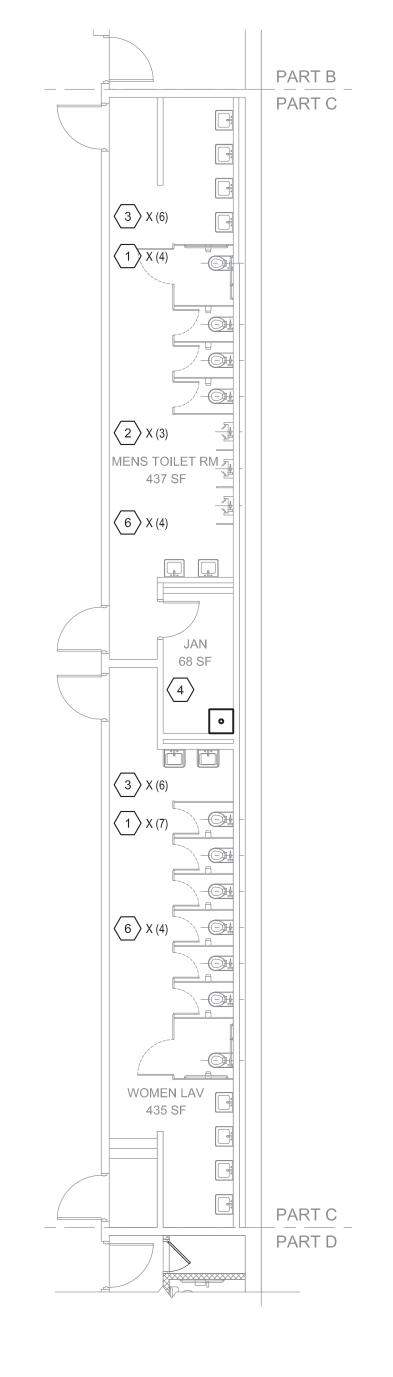
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**PD-101** 

PLUMBING FIRST **FLOOR PLAN AREA B - DEMOLITION** 











#### KEYED NOTES (#)

THE BUILDING.

- 1. PROVIDE WALL MOUNTED WATER CLOSET. PROVIDE 1" C., 2" V. & 4" SAN. BRANCH PIPING.
- 2. PROVIDE URINAL. PROVIDE ¾" C., 2" V. & 2" SAN. PIPING.
- PROVIDE LAVATORY. PROVIDE ½" C., ½" H., 1½" V. & 1½" SAN. PIPING.
   PROVIDE MOP SERVICE SINK AND ALL ½" C., ½" H., 1-1/2" SAN BRANCH PIPING.
- 5. PROVIDE FLOOR DRAIN WITH DEEP SEAL TRAP, TRAP PRIMER, 4" SAN., 2" V. & ½" C PIPING. EXTEND ½" C. TO COLD WATER TRAP PRIMER.
  6. GAS METER BY NATIONAL FUEL TO REMAIN.
- 7. PROVIDE 2" REDUCED PRESSURE ZONE BACKFLOW PREVENTION DEVICE.
- 8. PROVIDE 2" DOMESTIC WATER METER WITH INTEGRAL STRAINER IN COMPLIANCE WITH BUFFALO DIVISION OF WATER REQUIREMENTS.
  9. PROVIDE PEDESTAL EMERGENCY EYEWASH WITH ½" C. AND ½" H. TO MIXING VALVE AND 1½" SAN. REFER TO 12/P1-3
- 10. EXISTING SANITARY TO REMAIN.



#### BUILDINGS TO BE DEMOLISHED AND REPLACED WITH A NEW BUILDING

WATER AND SANITARY SEWERS: EXCAVATE DOWN AT THE EXTERIOR OF BUILDING AND SAW CUT AND DISCONNECT SANITARY SEWER AND DOMESTIC WATER SERVICE PIPING. SANITARY SEWER AND WATER SERVICE SHALL BE REMOVED OR ABANDONED IN PLACE BELOW GRADE. SERVICES SHALL BE CAPPED OR PLUGGED AT THE ENDS AND MARKED AS "ABANDONED IN PLACE". NEW SCHEDULE 40 SOLID CORE PVC SANITARY SEWERS SHALL BE PROVIDED BELOW THE FLOOR SLAB AND EXTENDED TO THE NEAREST SANITARY SITE MANHOLE. A NEW TYPE L COPPER OR DUCTILE IRON WATER SERVICE SHALL BE EXTENDED FROM THE CITY STREET MAIN TO THE BUILDING. THE WATER SERVICE SHALL ENTER THE BUILDING THROUGH THE FOUNDATION WALL AND FLOOR SLAB AND BE LOCATED INSIDE NEAR AN EXTERIOR WALL. EXISTING WATER METER PITS: METERS INSIDE STRUCTURES BELOW GRADE SHALL BE REMOVED. AN INVESTIGATION OF THE EXISTING METER SHALL BE CONDUCTED JOINTLY WITH CITY OF BUFFALO PARKS PERSONNEL TO ASSESS IT FOR SALVAGE VALUE FOR REUSE AT OTHER SITES. CONCRETE METER PITS SHALL BE REMOVED OR HAVE THE TOPS REMOVED AND REMAINING STRUCTURE ABANDONED IN PLACE

GAS SERVICE: COORDINATE WITH NATIONAL FUEL FOR THE REMOVAL OF GAS METER SET. ANY REMOVAL OF BELOW GRADE PIPING SHALL BE AS PER NATIONAL FUELS DISCRETION. A NEW METER SET AND SERVICE SIZED TO MATCH ANY BUILDING EQUIPMENT LOADS WILL BE PROVIDED BY NATIONAL FUEL. SCHEDULE 40 STEEL GAS PIPE EXTENDED TO ANY WATER HEATING, KITCHEN OR BUILDING HEATING EQUIPMENT INSIDE.

AN INVESTIGATION OF ALL EXISTING PLUMBING FIXTURES, WATER HEATERS AND SAFETY DEVICES SUCH AS EYEWASHES SHALL BE CONDUCTED JOINTLY WITH CITY OF BUFFALO PARKS PERSONNEL TO ASSESS SALVAGE VALUE FOR REUSE AT OTHER SITES. DISCONNECT AND REMOVE ANY FIXTURES AS REQUESTED BY THE CITY OF BUFFALO PARKS. SALVAGED EQUIPMENT SHALL BE REMOVED BY PARKS PERSONNEL OFF-SITE PRIOR TO THE DEMOLITION OF THE STRUCTURE. NEW PLUMBING FIXTURES INCLUDING WATER CLOSETS, URINALS, LAVATORIES, SINKS, MOP SERVICE SINKS, AND SHOWERS IF REQUIRED WILL BE PROVIDED. PLUMBING SPECIALTIES INCLUDING FLOOR DRAINS, FLOOR CLEANOUTS, GREASE INTERCEPTORS, WATER HAMMER ARRESTORS AND WALLS HYDRANTS WILL BE PROVIDED. ELECTRIC OR GAS WATER HEATERS SIZED TO SERVE THE FIXTURE AND EQUIPMENT LOADS WILL BE PROVIDED. REQUIRED SAFETY DEVICES SUCH AS EYEWASHES WILL BE PROVIDED FOR BUILDINGS INCLUDING KITCHENS OR WATER TREATMENT EQUIPMENT FOR SWIMMING POOLS.


WATER SERVICE ENTRANCE: COORDINATE WITH THE CITY OF BUFFALO PARKS FOR THE DISCONNECTION AND REMOVAL OF THE BUILDING SERVICE SUPPLY, WATER METER, ANY SUB-METERS AND ALL BACKFLOW PREVENTION DEVICES. THE METERS AND BACKFLOW PREVENTION DEVICES SHALL BE JOINTLY CONDUCTED FOR SALVAGE VALUE AND REUSE AT OTHER SITES BY BUFFALO PARKS PERSONNEL AND THE CONTRACTOR. THE WATER METERS AND BACKFLOW PREVENTION DEVICES SALVAGED SHALL BE REMOVED BY BUFFALO PARKS PERSONNEL OFF-SITE PRIOR TO THE DEMOLITION OF THE STRUCTURE. A NEW WATER SERVICE SUPPLY WITH METER SET WILL BE LOCATED IN THE INTERIOR OF THE BUILDING, INSTALLED ADJACENT TO AN EXTERIOR WALL AND FITTED WITH A REDUCED PRESSURE ZONE BACKFLOW DEVICE. A WATER METER COMPLYING WITH THE CITY OF BUFFALO DIVISION OF WATER REQUIREMENTS WILL BE PROVIDED. A REDUCED PRESSURE ZONE BACKFLOW PREVENTION DEVICE WILL BE PROVIDED ON THE DOMESTIC WATER SERVICE AND IN COMPLIANCE WITH THE CITY OF BUFFALO DIVISION OF WATER AND NEW YORK STATE HEALTH DEPARTMENT CODE REQUIREMENTS.

THE CONTRACTOR SHALL PROVIDE FOR THE COORDINATION AND THE TIMING OF UTILITY REMOVALS WITH UTILITY AGENCIES. THE CONTRACTOR SHALL PROVIDE FOR CONTACT, APPLICATION AND ALL COST ASSOCIATED WITH REMOVAL WORK AND COMPLETE THE WORK IN COMPLIANCE WITH EACH AGENCIES WRITTEN REQUIREMENTS. CONTACTS SHALL INCLUDE THE BUFFALO DIVISION OF WATER, BUFFALO SEWER AUTHORITY AND NATIONAL FUEL.

APPLICATIONS FOR ALL UTILITY SERVICES WILL BE REQUIRED TO THE RESPECTIVE UTILITIES FOR THE GAS, ELECTRIC, WATER SERVICE, DOMESTIC WATER BACKFLOW PREVENTION AND SANITARY SEWER SYSTEMS. APPLICATIONS AND DESIGN SUBMISSIONS MUST INCLUDE CAPACITIES AND DEMONSTRATION OF CODE COMPLIANCES.

APPLICATIONS INCLUDE THE ADDED DISCHARGE CAPACITY TO THE CITY SANITARY SEWER SYSTEM, WATER SERVICES AND GAS INCLUDE DESIGN SUBMISSIONS FOR APPROVAL, TAPPING PERMITS BY CONTRACTORS AND FINAL INSPECTION APPROVALS.

ALL REMAINING ITEMS SHALL BE DEMOLISHED AND REMOVED FROM THE SITE AS PART OF THE GENERAL CONSTRUCTION DEMOLITION OF

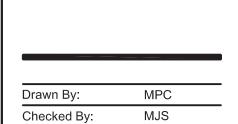

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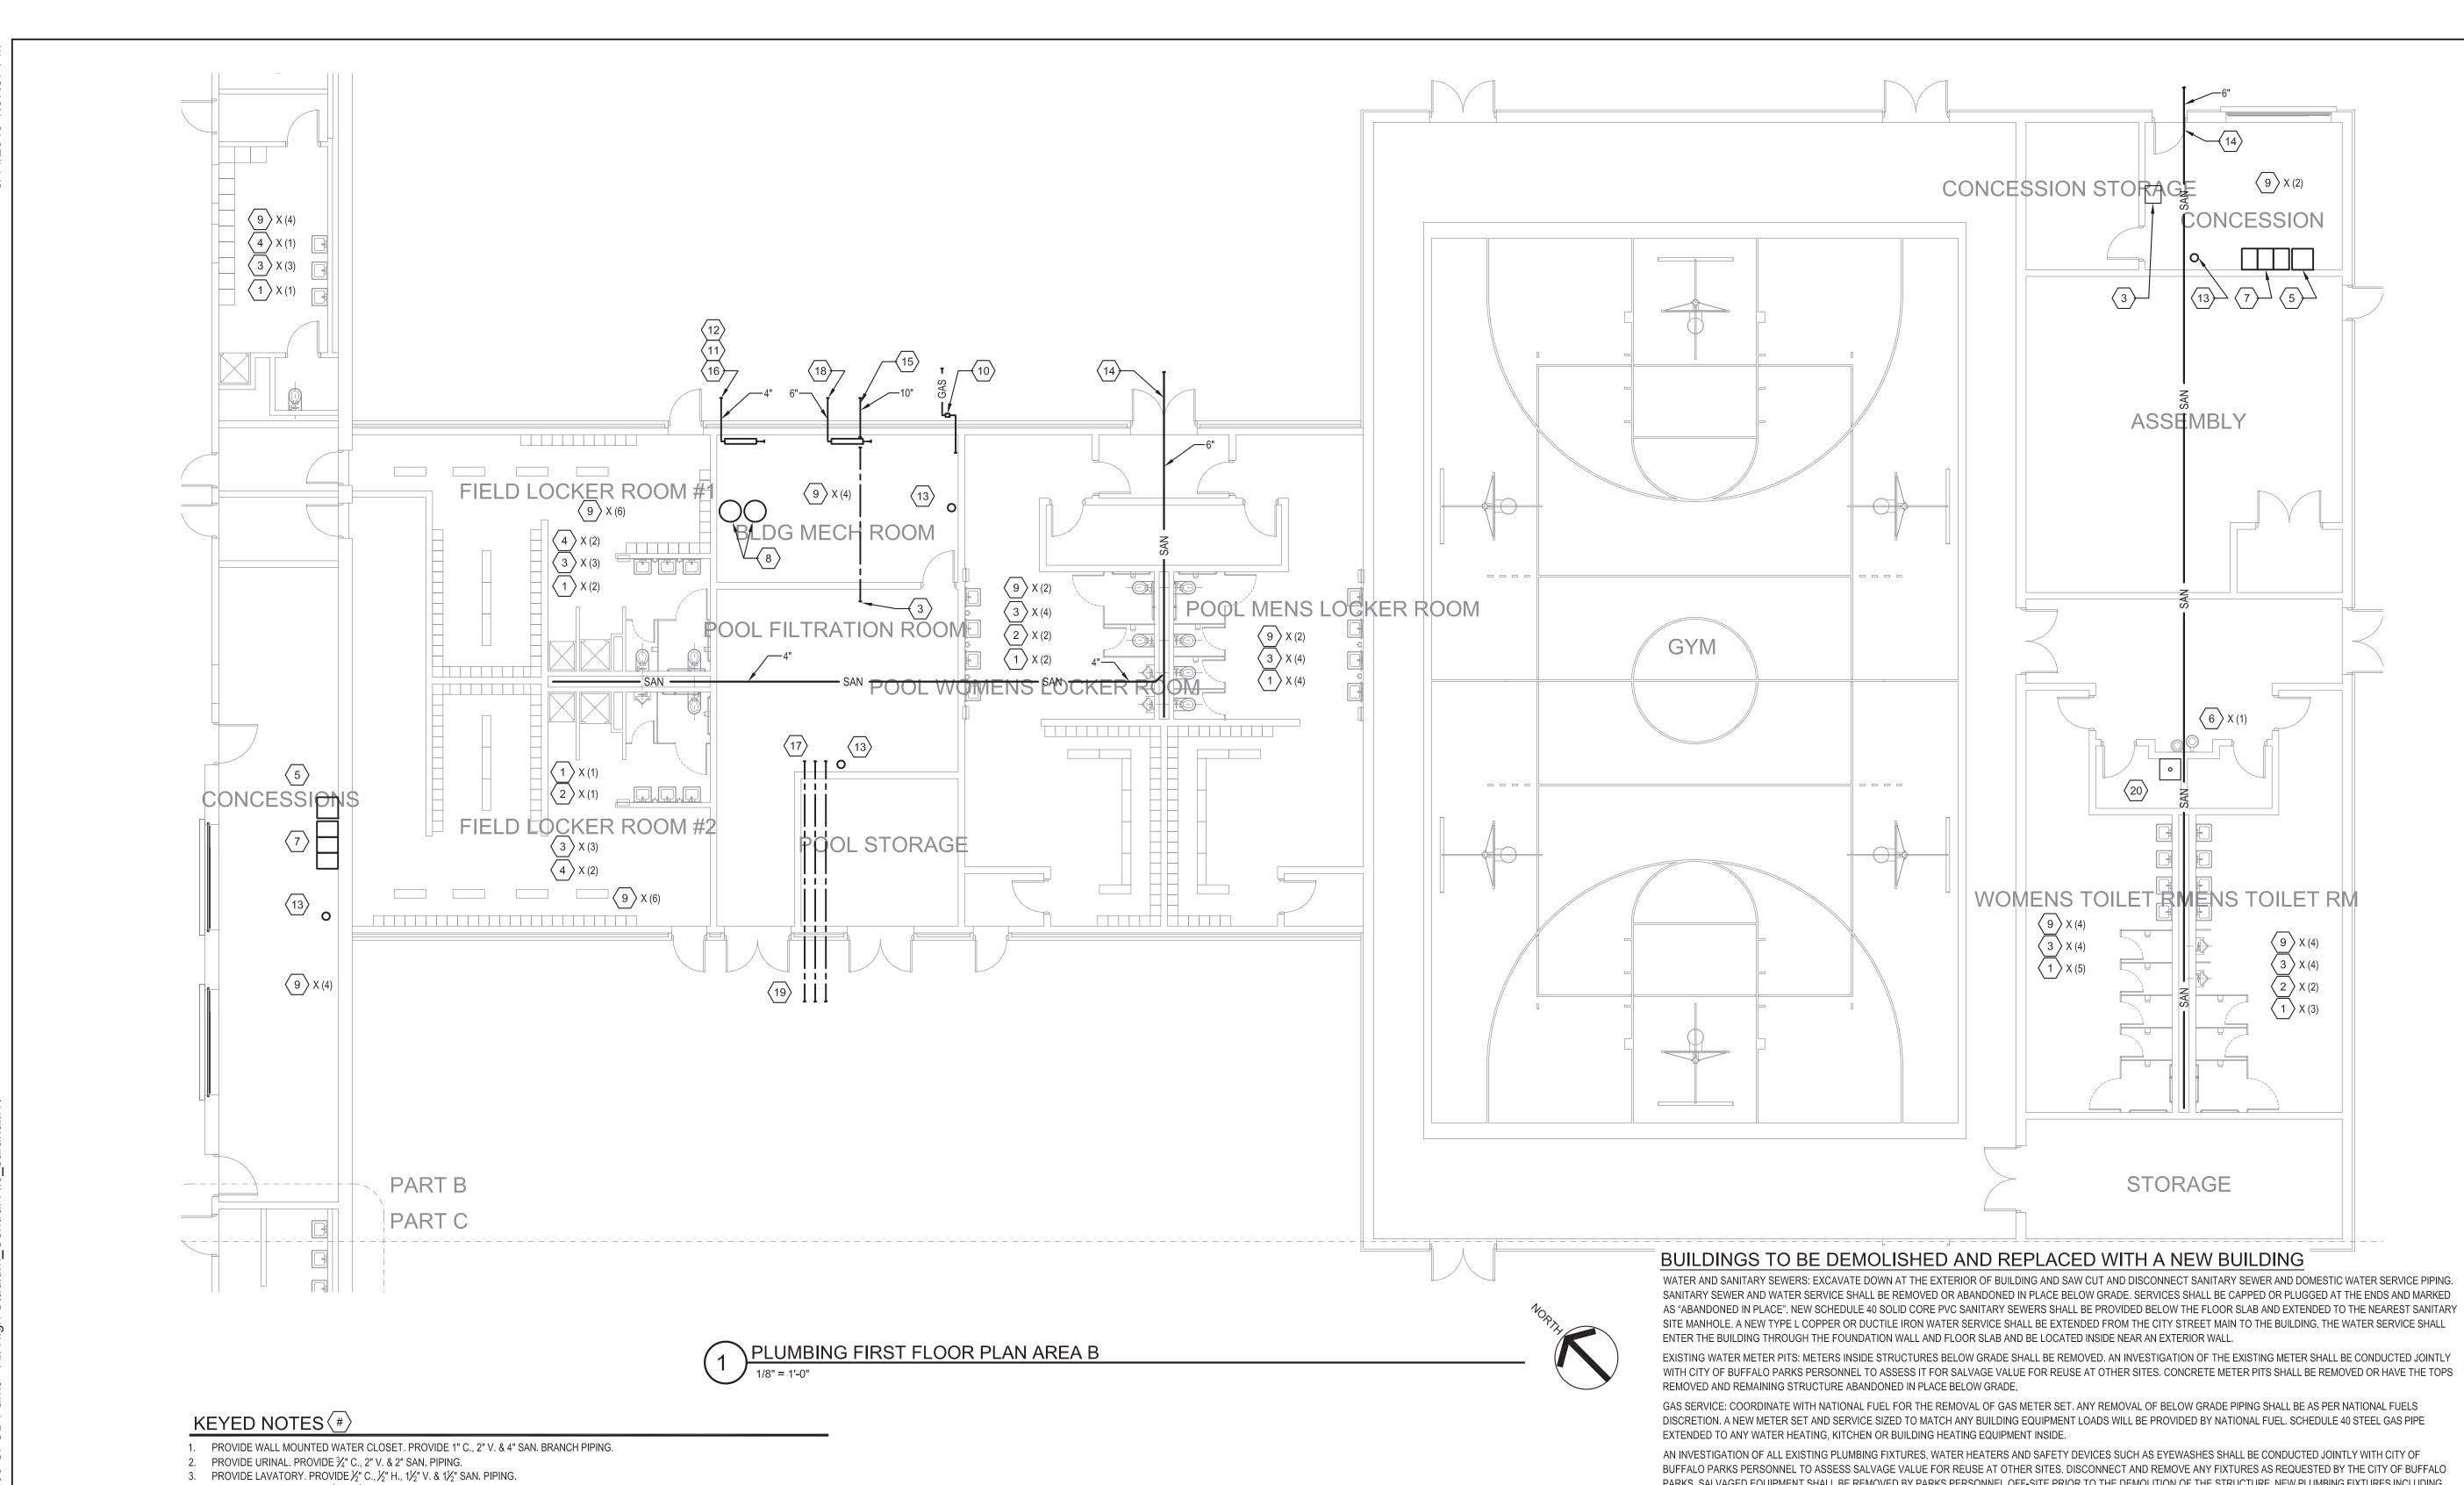
Revision

City of Buffalo Parks & Buffalo Public School Facilities Survey & Design Development SWBR Project Number 18630.00

Community Foundation for Greater Buffalo 726 Exchange Street, Suite 525 Buffalo, NY 14210

P-101

JBW Masten
PLUMBING FIRST
FLOOR PLAN AREA
B - C & D



- 4. PROVIDE SHOWER VALVE, ½" C., ½" H PIPING. SHOWER WALLS AND FLOOR SHALL BE PART OF GENERAL CONSTRUCTION. PROVIDE 2"
- SAN AND 1-1/2" V. PIPING.
- 5. PROVIDE 70 LBS. CAPACITY GREASE INTERCEPTOR AND FLOW CONTROL DEVICE. PROVIDE ADA WATER COOLER BOTTLE FILLER STATION.
- 7. 3 BASIN STAINLESS STEEL SINK AGAINST WALL.
- 8. PROVIDE PARALLEL DIRECT VENT HIGH EFFICIENCY GAS FIRED WATER HEATERS.
- 9. PROVIDE FLOOR DRAIN WITH DEEP SEAL TRAP, TRAP PRIMER, 4" SAN., 2" V. & ½" C PIPING. EXTEND ½" C. TO COLD WATER TRAP PRIMER. 10. GAS METER AND SERVICE BY NATIONAL FUEL 2 M METER SET.. (BEST STREET).
- 11. PROVIDE PARALLEL 4" REDUCED PRESSURE ZONE BACKFLOW PREVENTION DEVICE. 12. PROVIDE 4" DOMESTIC WATER METER WITH INTEGRAL STRAINER IN COMPLIANCE WITH BUFFALO DIVISION OF WATER REQUIREMENTS.
- 13. PROVIDE PEDESTAL EMERGENCY EYEWASH WITH ½" C. AND ½" H. TO MIXING VALVE AND 1¼" SAN. 14. 6" SANITARY TO STREET OR SITE MANHOLE.
- 15. POOL EQUIPMENT BACKWASH TO SITE SANITARY SEWER. (BEST STREET). 16. 4" DUCTILE IRON WATER SERVICE (DOMESTIC). (BEST STREET).
- 17. POOL EQUIPMENT ROOM TO INCLUDE PUMP, FILTRATION AND TREATMENT. 18. 6" DUCTILE IRON WATER SERVICE (FIRE PROTECTION SPRINKLERS). (BEST STREET).
- 19. PIPING BETWEEN POOL AND POOL EQUIPMENT ROOM.
- 20. PROVIDE MOP SERVICE SINK.

SERVING KITCHENS ARE LIMITED TO "SERVING USE" WHERE THE USERS BRING THEIR OWN FOOD, MATERIALS AND UTENSILS AND LEAVE THE SITE WITH THEIR MATERIALS, ITEMS PROVIDED IN THE BUILDING ARE LIMITED TO COUNTERS AND SINKS FOR CLEANUP TO INCLUDE A 3-BASIN SINK MINIMUM. 3-BASIN SINKS REQUIRE A GREASE INTERCEPTOR DEVICE PER THE INTERNATIONAL PLUMBING CODE, CITY OF BUFFALO

ADDITIONAL "SERVING KITCHEN" ITEMS INCLUDE PROVIDING WORKTABLES, COUNTERS, SOME CASEWORK FOR STORAGE AND A SINK FOR HAND WASHING.

#### SERVING KITCHEN IN CONCESSIONS

PLUMBING DEPARTMENT AND HEALTH CODES.

AN INVESTIGATION OF ALL EXISTING PLUMBING FIXTURES, WATER HEATERS AND SAFETY DEVICES SUCH AS EYEWASHES SHALL BE CONDUCTED JOINTLY WITH CITY OF BUFFALO PARKS PERSONNEL TO ASSESS SALVAGE VALUE FOR REUSE AT OTHER SITES. DISCONNECT AND REMOVE ANY FIXTURES AS REQUESTED BY THE CITY OF BUFFALO PARKS. SALVAGED EQUIPMENT SHALL BE REMOVED BY PARKS PERSONNEL OFF-SITE PRIOR TO THE DEMOLITION OF THE STRUCTURE. NEW PLUMBING FIXTURES INCLUDING WATER CLOSETS, URINALS, LAVATORIES, SINKS, MOP SERVICE SINKS, AND SHOWERS IF REQUIRED WILL BE PROVIDED. PLUMBING SPECIALTIES INCLUDING FLOOR DRAINS, FLOOR CLEANOUTS, GREASE INTERCEPTORS, WATER HAMMER ARRESTORS AND WALLS HYDRANTS WILL BE PROVIDED. ELECTRIC OR GAS WATER HEATERS SIZED TO SERVE THE FIXTURE AND EQUIPMENT LOADS WILL BE PROVIDED. REQUIRED SAFETY DEVICES SUCH AS EYEWASHES WILL BE PROVIDED FOR BUILDINGS INCLUDING KITCHENS OR WATER TREATMENT EQUIPMENT FOR SWIMMING POOLS.

WATER SERVICE ENTRANCE: COORDINATE WITH THE CITY OF BUFFALO PARKS FOR THE DISCONNECTION AND REMOVAL OF THE BUILDING SERVICE SUPPLY, WATER METER, ANY SUB-METERS AND ALL BACKFLOW PREVENTION DEVICES. THE METERS AND BACKFLOW PREVENTION DEVICES SHALL BE JOINTLY CONDUCTED FOR SALVAGE VALUE AND REUSE AT OTHER SITES BY BUFFALO PARKS PERSONNEL AND THE CONTRACTOR. THE WATER METERS AND BACKFLOW PREVENTION DEVICES SALVAGED SHALL BE REMOVED BY BUFFALO PARKS PERSONNEL OFF-SITE PRIOR TO THE DEMOLITION OF THE STRUCTURE. A NEW WATER SERVICE SUPPLY WITH METER SET WILL BE LOCATED IN THE INTERIOR OF THE BUILDING, INSTALLED ADJACENT TO AN EXTERIOR WALL AND FITTED WITH A REDUCED PRESSURE ZONE BACKFLOW DEVICE. A WATER METER COMPLYING WITH THE CITY OF BUFFALO DIVISION OF WATER REQUIREMENTS WILL BE PROVIDED. A REDUCED PRESSURE ZONE BACKFLOW PREVENTION DEVICE WILL BE PROVIDED ON THE DOMESTIC WATER SERVICE AND IN COMPLIANCE WITH THE CITY OF BUFFALO DIVISION OF WATER AND NEW YORK STATE HEALTH DEPARTMENT CODE REQUIREMENTS.


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387 East Main Street Rochester NY 14604 WATTS ARCHITECTURE & ENGINEERING

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MPC Checked By: MJS Project Manager: RCP


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PLUMBING FIRST FLOOR PLAN AREA



#### LEGEND:

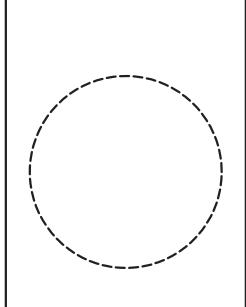FIELD LIGHTING

PATHWAY LIGHTING

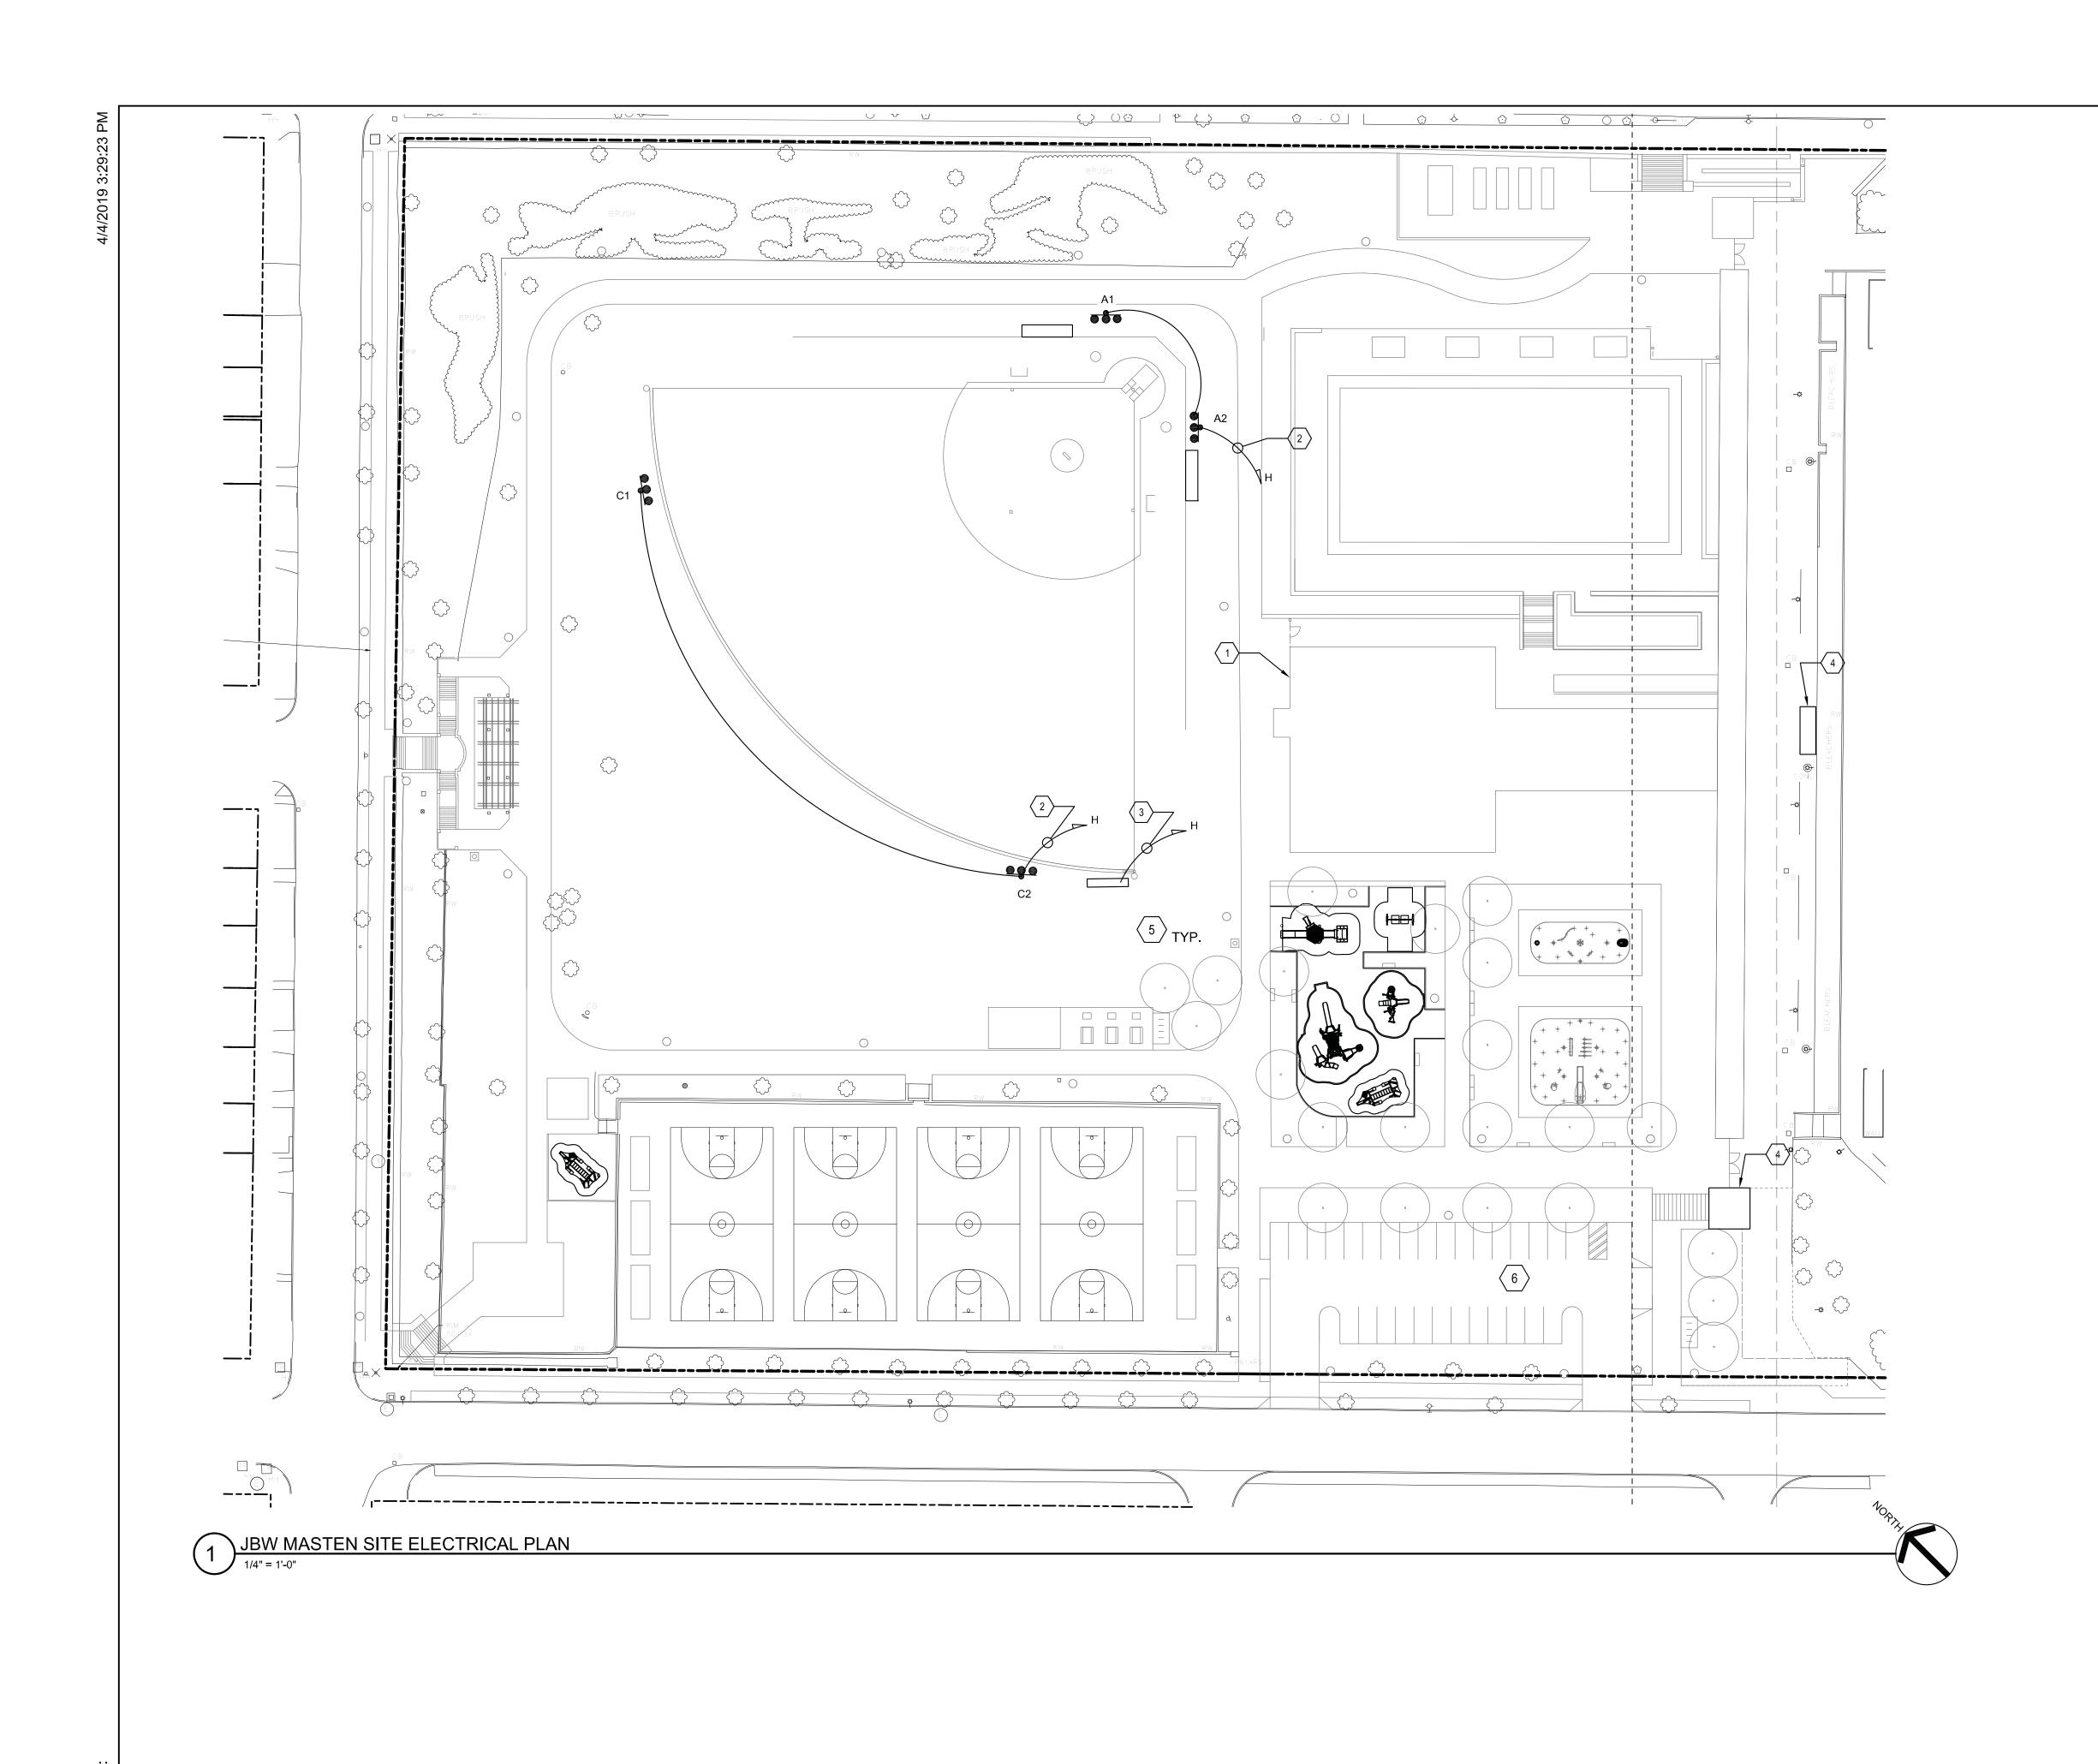Y— LAMPPOLE TO REMAIN

SECURITY CAMERA

SCOREBOARD

BRANCH CIRCUIT TO PANELBOARD. LETTERING INDICATES PANELBOARD DESIGNATIONS. QUANTITY OF ARROWHEADS INDICATE QUANTITY OF BRANCH CIRCUITS.

#### KEYED DRAWING NOTES: #

- 1. PROVIDE 208V, 3 PHASE, 200 AMP PANEL 'H' TO BE USED FOR NEW FIELD LIGHTING.
- PROVIDE 208V, 3 PHASE, 40 AMP CIRCUIT CONSISTING OF (3)#6
   AWG CONDUCTORS WITH (1) #10 EQUIPMENT GROUNDING
   CONDUCTOR IN 1" CONDUIT. EACH LAMP POLE SHALL BE
   PROVIDED (1) CIRCUIT.
- 3. PROVIDE 2 POLE, 60 AMP NEMA 3R DISCONNECT SWITCH AND A CIRCUIT CONSISTING OF (2) #4 AWG CONDUCTORS WITH (1) #10 EQUIPMENT GROUNDING CONDUCTOR IN 1" CONDUIT TO PANEL 'H'.
- 4. PROVIDE 2 POLE, 60 AMP NEMA 3R DISCONNECT SWITCH AND A CIRCUIT CONSISTING OF (2) #6 AWG CONDUCTORS WITH (1) #10 EQUIPMENT GROUNDING CONDUCTOR IN 1" CONDUIT TO EXISTING PANEL IN CONCESSION BUILDING.
  5. PROVIDE (2) #6 AWG CONDUCTORS & (1) #12 EGC IN ³/₄"
- CONDUIT LOOPED TO EACH PATHWAY LIGHTING FIXTURE.
  PROVIDE HANDHOLE EVERY 350 FEET TO SUIT FIELD
  CONDITIONS.


  6. PARKING LOT LIGHTS SHALL BE SAME AS PATHWAY LIGHITNG
  FIXTURES MOUNTED ON 25 FOOT POLE. PROVIDE (2) #6 AWG

CONDUCTORS & (1) #12 EGC IN  $\frac{3}{4}$ " CONDUIT LOOPED TO EACH

POLE SUMMA	ARY	

PARKING LOT FIXTURE.



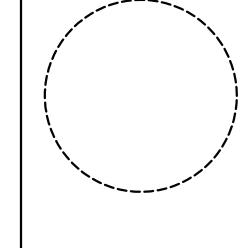

Drawn By:	RWL
Checked By:	MJS
Project Manager:	RCP

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ELECTRICAL SITE PLAN

