

# Grabiarz School of Excellence













## SITE LEGEND:

- Multipurpose Synthetic Field
- 2 Shade Shelter / Pavilion
- 3 Concessions / Restrooms
- 4 Gateways
- 5 Existing Parking
- 6 Play Equipment (Ages 2-5)
- 7 Play Equipment (Ages 5-12)
- 8 Existing Play Equipment
- 9 Pathways / Plantings
- 10 Crosswalk Improvements
- Pathway Lighting
- ••• Field Lighting
- Scoreboard

## Grabiarz School of Excellence











General

G-001 General Notes, Legends & Drawing List

Landscape L-000 Existing Conditions/ Survey
L-002 Demolition Plan
L-101 Site Layout Plan

C-101 Grading, Drainage & Utility Plan

Electrical E-101 Electrical Site Plan

#### DRAWING LIST - GRABIARZ PARK

**Drawing symbols** Exterior elevation 001) OR 100 Door numbers View title —— Detail no. Elevation no. — Window type Title X Title
SCALE: X"=1'-0" 101 Room number Drawing no. — Building / wall section cut Interior elevations  $\triangle$ Revision ✓ Detail no. Elevation no.— C12 OR C12 Partition type Plan key note Drawing no. — Detail section cut Structural grid (1) Demolition key note Ceiling type and height A-XXX DRAWING NO. Detail - blow up Accessibility V/HAU Detail no. Visual / hearing A-XXX accommodation unit

Accessible unit

Material	symbols
Matchai	Syllibols


	Undisturbed earth		Steel - large scale (Other metals as noted)	Batt insulation
	Gravel or crushed stone		Steel - small scale (Other metals as noted)	Rigid insulation
	Stone	$\boxtimes$	Wood framing (continuous)	Wood blocking (intermittent)
4	Concrete		Finish wood	
	Concrete masonry unit		Plywood	
	Brick		Gypsum, sand, mortar	
	Concrete masonry unit		Finish wood Plywood	Wood blocking (intermittent)

#### Architectural / Structural abbreviations

3	Anchor bolt		Drainage waste & vent	LH	Left hand, Latent heat	RF	Resilient flooring
С	Air condition(ing) (ed)		Drawing	LIN	Linear	RFG	Roofing
CCU CCU	Accessible Air cooled condensing unit		Dowel East	LKR LL	Locker Live load	RH RM	Right hand, Roof hatch Room
Cl	American Concrete Institute	EA	Each	LLH	Long leg horizontal	RO	Rough opening
CT	Acoustical ceiling tile	EBCNYS	Existing Building Code of New York State	LLV	Long leg vertical	ROW	Right of way
CM	Asbestos containing material		Electrical contractor	LOC	Location	RTU	Roof top unit
COUS PNL	. Acoustical panel Access panel		Each face Exterior insulation and finish system	LRFD LT	Load & resistance factor design Light	RV RWB	Roof vent Rubber wall base
DL	Additional		Expansion joint	LTG	Lighting	S	South
)J	Adjustable, adjacent	ELAS	Elastomeric	LWC	Light-weight concrete	SAB	Sound attenuation batts
DΗ	Adhesive		Elevation	MACH	Machine	SAN	Sanitary
F GR	Above finished floor		Electric(al) Elevator	MAINT MAS	Maintenance Masonry	SC SCHED	Solid core, Shading coefficie Schedule
HU	Aggregate Air handling unit		Entry mat, Expanded metal	MATL	Material	SEAL	Sealer on floor (finish)
SC	American Institute of Steel Construction		Emergency	MAX	Maximum	SECT	Section
SI	American Iron and Steel Institute		Enclosure	MC	Mechanical contractor	SF	Square foot, Safety factor
.T	Alternate		Engineer	MCB	Metal corner bead	SFRM	Sprayed fire-resistive
.UM NOD	Aluminum Anodized		Edge of slab Electric panel	MDO MDF	Medium density overlay Medium density fiberboard	SGT	Material Structural glazed tile
PROX	Approximate		Equal	MECH	Mechanical	SHT	Sheet
RCH	Architect(ural)	EQUIP	Equipment	MEP	Mechanical, electrical, plumbing and fire protection	SHR	Shower
RD	Auxillary roof drain		Emergency shower	MEZZ	Mezzanine	SIM	Similar
SD STM	Allowable stress design American Society for Testing and Materials		Et cetera Existing to remain	MFR MH	Manufacturer Manhole	SOG SP	Slab on grade Standpipe, Sump pit
VP	Acoustical wall panel		Each way	MM	Millimeter	SPA	Spaces
VS	American Welding Society		Electric water cooler	MIFRC	Mastic/intumescent fire-resistive coating	SPKR	Speaker
ΑT	Batten	EXIST	Existing	MIN	Minimum	SPEC	Specification
В	Back to back		Excavation, Excavate	MISC	Miscellaneous	SQ	Square
BD CNYS	Base board  Building Code of New York State		Expand, Expansion	MLWK MO	Millwork	SRD SS	Secondary roof drain Service sink
TUM	Building Code of New York State Bituminous		Exterior, External, Extinguisher Face to face	MRK BD	Masonry opening Marker board	SSM	Service sink Solid surface material
)	Board		Fire alarm annunciator panel	MTD	Mounted	SSP	Stainless steel pipe
.DG	Building	FACP	Fire alarm control panel	MTL	Metal	SST	Stainless steel
.KG	Blocking	FD	Floor drain	MULL	Mullion	ST	Stain
Л Эт	Beam, Benchmark		Foundation  Fire extinguisher	N NAT	North Notural	STA	Station
TC R	Bottom Bedroom		Fire extinguisher Fire extinguisher cabinet	NAT NCOMBL	Natural Noncombustible	STC	Sound transmission class Standard
K RG	Bearing		Fire hose cabinet	NIC	Not in contract	STIFF	Stiffener
RZ	Bronze	FIN	Finish(ed)	NO OR #	Number	STL	Steel
SMT	Basement	FIXT	Fixture	NOM	Nominal	STOR	Storage
TWN	Between		Flashing	NORM	Normal	STR	Straight, Stringers
JR V	Built up roofing Both ways		Flexible Fluorescent	NRC NTS	Noise reduction coefficient Not to scale	STRUCT	Structural Suspended
CTV	Closed circuit television		Flooring, flange	NWC	Normal weight concrete	SV	Sheet vinyl
AΒ	Cabinet		Finished opening	0/0	Out to out	SY	Square yard
3	Catch basin, Corner bead		Fire protection, Fireproof	OA	Overall, Outside air	Т	Tread
H BD	Chalkboard		Fire retardant treated wood	OC	On center	T/	Top of
EM E	Cement Contractor furnished	FT FTG	Foot, Feet Footing	OD OF/CI	Outside diameter Owner furnished. Contactor installed	T&B T&G	Top and bottom Tongue and groove
MF	Cold-formed metal framing		Finned tube radiation	OF/OI	Owner furnished, Owner installed	TEL	Telephone
F/CI	Contractor furnished/ Contractor installed		Furnace, Furniture, Furnish	OFD	Overflow drain	THRES	Threshold
F/OI	Contractor furnished/ Owner installed		Future	OFF	Office	TEMP	Temporary
3	Corner guard	FWC	Fabric wall covering	OH	Opposite hand	TER	Terrazzo
4	Coat hook Cast iron	GA GAL	Gage Gallon	OH DR OPNG	Overhead (coiling) door Opening	THK TK BD	Thick(ness) Tack board
Р	Cast in place, Cast iron pipe		Galvanized	OPP	Opposite	TMPD	Tempered
J	Control joint		Grab bar	OPT	Optional, Optimum	TOC	Top of concrete
	Centerline		General contract(or)	OZ	Ounce	TOM	Top of masonry
.G .O	Ceiling		Glass fiber reinforced concrete	PA PBD	Public address Particleboard	TOPO TOS	Topography, Topographic
.0 .R	Closet Clear, Color		Glass fiber reinforced gypsum Glass. Ground level	PC	Plumbing contractor, Portland cement	TOW	Top of steel Top of wall
MT	Ceramic mosaic tile		Glass block	PCC	Precast concrete	TPD	Toilet paper dispenser
ИU	Concrete masonry unit		Glued laminated beam	PCT	Porcelain ceramic tile	TSTAT	Thermostat
NTR	Counter		Grade, Gross	PED	Pedestal	TV	Television
)	Cleanout, Cased opening, Company		Glazed wall tile	PEND	Pendant	TYP	Typical
DL DNC	Column Concrete	GYP GYP BD	Gypsum board	PER PERF	Period Perforated	UUC	Heat transfer coefficient Undercut
ONF	Conference		Gypsum plaster	PGBD	Peg board	UCL	Under cabinet lighting
NNC	Connect(ion)	НВ	Hose bibb	PL	Plate, Property line	UGND	Underground
ONSTR	Construction		Hollow core, Hose cabinet	PLF	Ponds per linear foot	UH	Unit heater
ONT ONTR	Continue(ous)		Handicapped Hardware	PLAM PLAS	Plastic laminate Plaster	UL UNEX	Underwriter's laboratories Unexcavated
OORD	Contract(or) Coordinate		Hardware	PLAS PLB	Plaster	UNEX	Unexcavated Unfinished
PT	Carpet		Hollow metal	PLYWD	Plywood	UON	Unless otherwise noted
SJ	Construction joint	НО	Hold open	PNL	Panel	UTIL	Utility
SK	Counter sunk		Horizontal	POL	Polished	UV	Unit ventilator
Γ ΓR	Ceramic tile, Count, Current transformer Center	HP HR	High point, Horsepower Hour	PORC POS	Porcelain Positive, Position	VARN VB	Varnish(ed) Vinyl base
N N	Center Cold water piping, Casement window		Hollow structural section	PPT	Pressure-preservative treated	VCT	Vinyl composition tile
J	Cubic		Height	PR	Pair	VENT	Ventilation
JH	Cabinet unit heater	HTG	Heating	PREFAB	Prefabricate	VERT	Vertical
J YD	Cubic yard		Heater	PREFIN	Prefinish	VEST	Vestibule
	Deep, Depth Penny (nail)		Heating, ventilating and air conditioning Hot water	PREP PROJ	Preparation Project	VIF VIN	Verify in field Vinyl
)	Penny (naii) Bar diameter	HYD	Hydrant Hydrant		Project N Projection screen	VIN	Vinyi Volume
3L	Double	ID	Inside diameter	PSF	Pounds per square foot	VR	Vapor retarder
EFS	Direct-applied exterior finish system		Inches	PSI	Pounds per square inch	VT	Vinyl tile
EG TMO	Degree		Included	PT	Paint, Post tension	V SHT	Vinyl sheet
EMO EPT	Demolition Department		Incandescent Information	PTN PVC	Partition Polyvinyl chloride (plastic)	VWC W	Vinyl wall covering West
ET	Detail		Insulation	PVG	Paving	W/	With
≣'	Drinking fountain	INTERM	Intermediate	QT	Quarry tile	WC	Water closet, Wall covering
A OR ø	Diameter	INT	Interior	QTR	Quarter	W/O	Without
AG	Diagonal, Diagram		Janitor	QTY	Quantity	WDW	Wood
M FF	Dimension Diffuser		Joist Joint	R RB	Riser, Radius, Thermal resistance Rubber base, Resilient base	WDW WF	Window Wide flange
rr R	Direction	KIP	1000 Pounds	RCP	Reinforced concrete pipe, Reflected ceiling plan	WD GD	Wood guard
SP	Dispenser		Kitchen	RD	Roof drain, Road	WH	Water heater
V	Division	KO	Knockout	REC	Recessed	WI	Wrought iron
MPF	Damp proofing		Kick plate	REF	Refrigerator	WM	Wire mesh
-	Dead load		Liter, Angle	REFL	Reflect	WP	Waterproofing, Working poir
N C	Down Ditto		Laminate(d)	REG REINF	Register, Regulation Reinforced	WR W RECPT	Water repellent, weather res Waste receptacle
) ?	Ditto Door, Drive		Laundry Lavatory	REINF	Reinforced Required	WSCT	Waste receptacle Wainscot
3	Downspout		Pound	RESIL	Resilient	WT	Weight, Watertight, Water to
N	Dishwasher	LBL LD	Label	REV	Revision	WWF X	Welded wire fabric By



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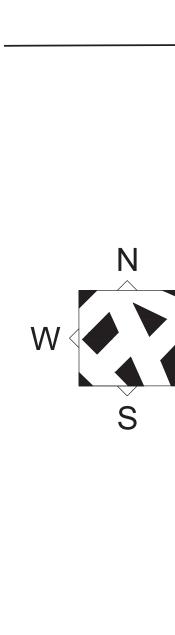
Revisions

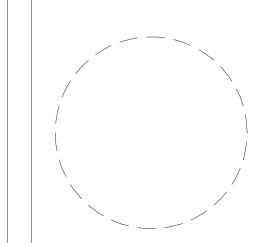
City of Buffalo Parks & Buffalo Public School Facilities Survey & Design Development SWBR Project Number 18630.00

**Community Foundation for** Greater Buffalo 726 Exchange Street, Suite 525 Buffalo, NY 14210

G-001

Grabiarz General Notes, Legends & Drawing List



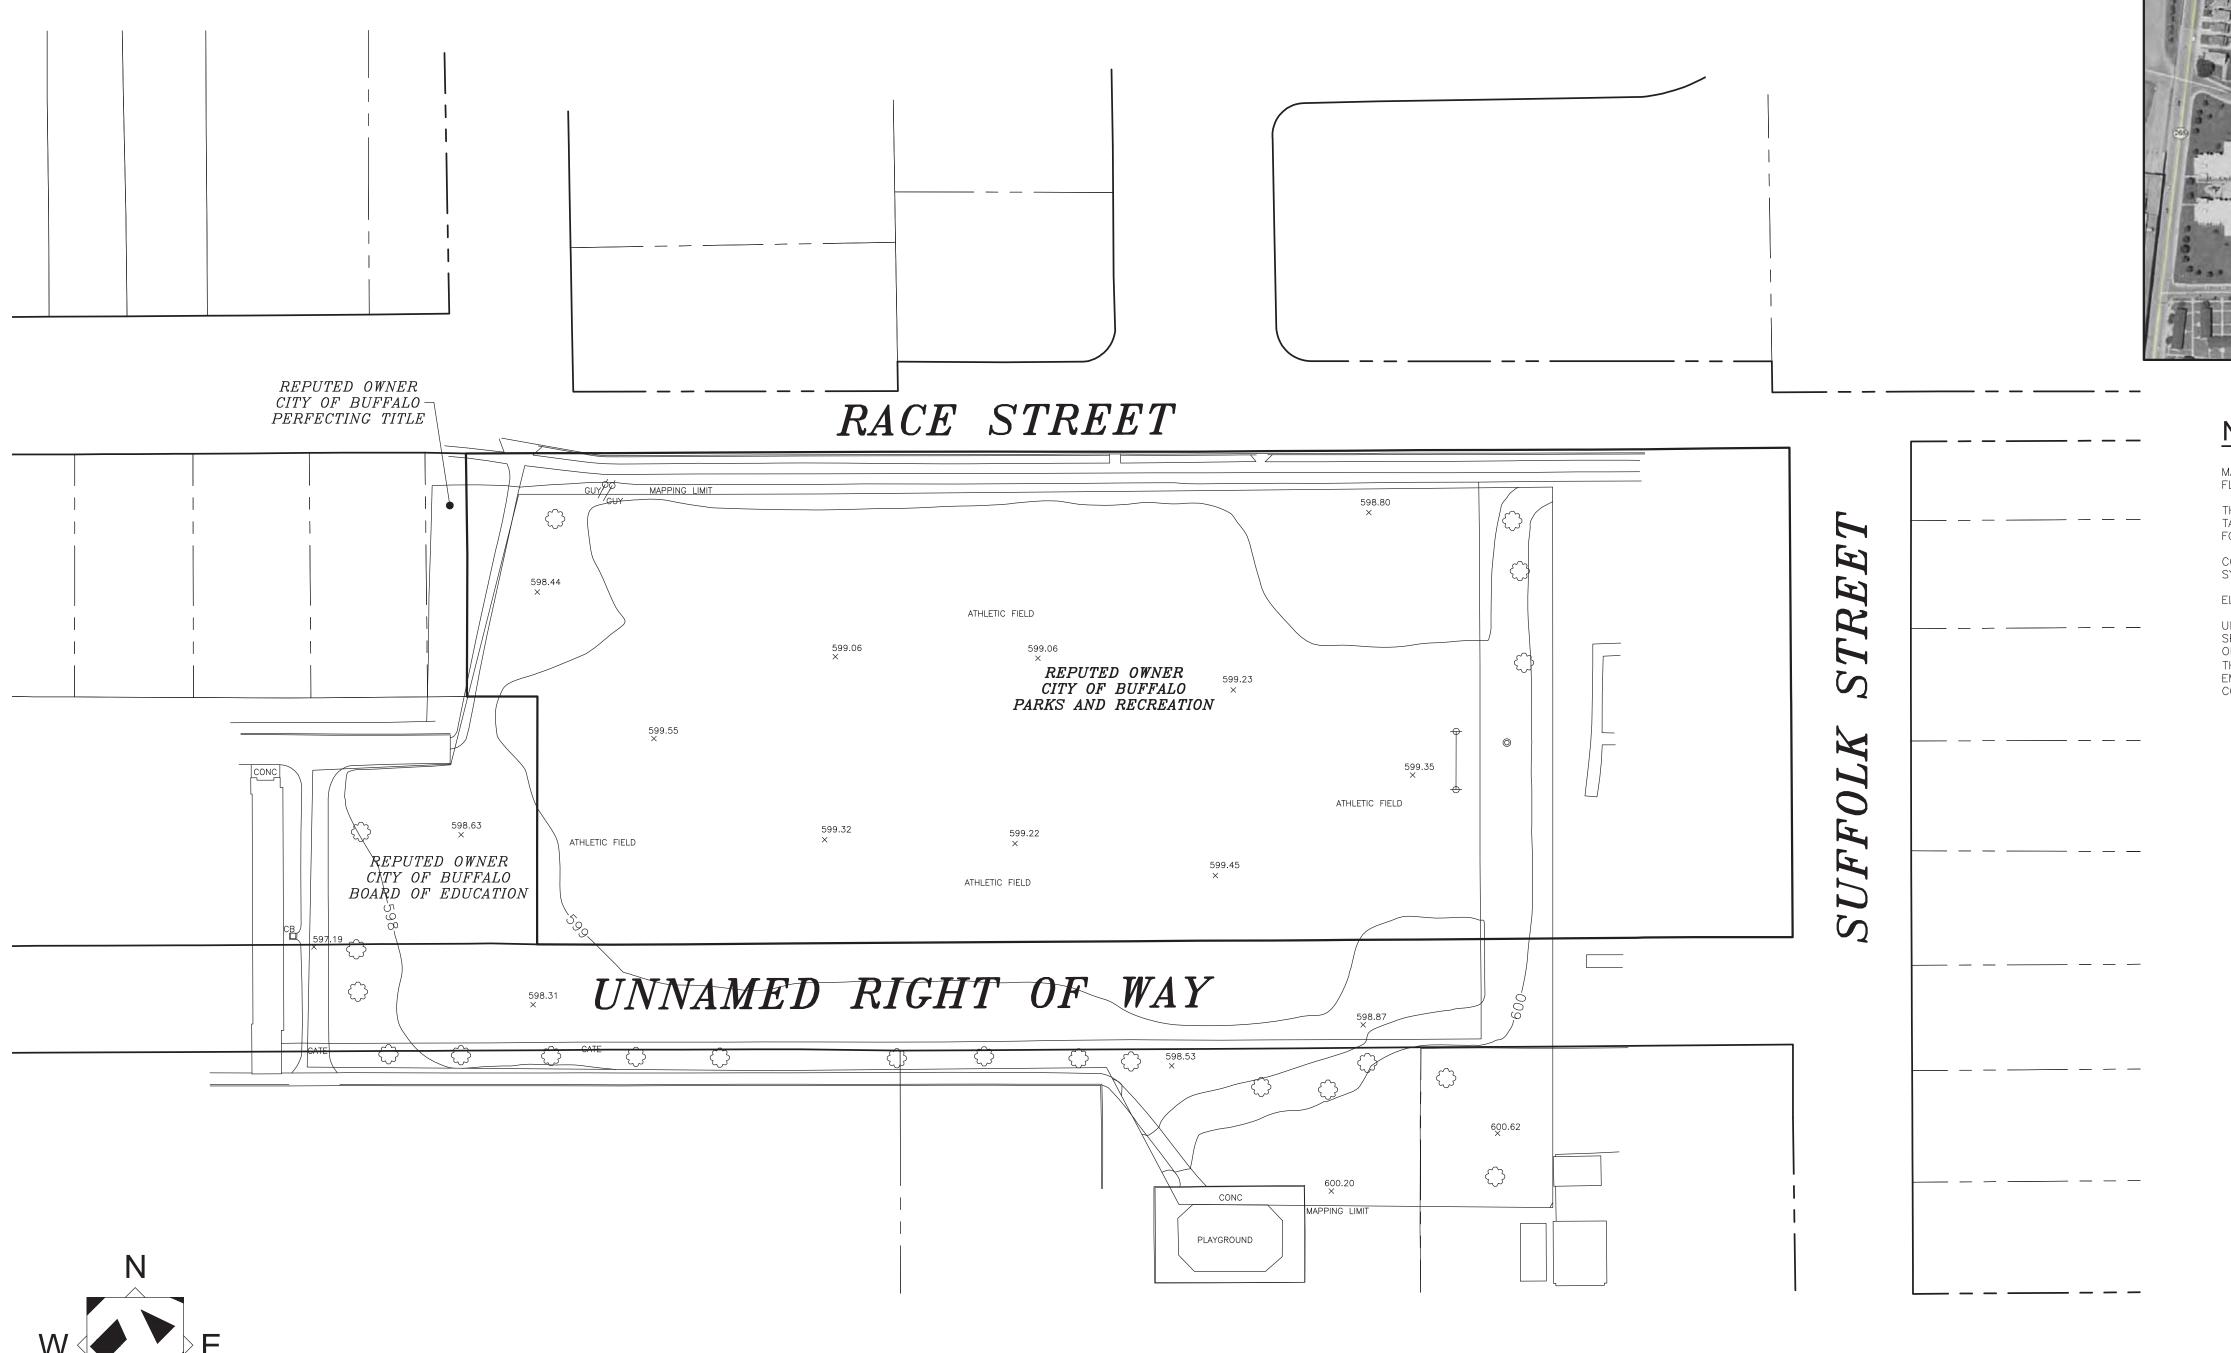

GRAPHIC SCALE

( IN FEET ) 1 inch = 40 ft.



**VICINITY MAP** 

### NOTES:

MAPPING COMPILED BY PHOTOGRAMMETRIC METHODS FROM AERIAL PHOTOGRAPHY FLOWN DECEMBER 2018

THE PROPERTY LINES SHOWN ARE APPROXIMATE ONLY AND ARE BASED ON GIS TAX MAP INFORMATION. A COMPLETE BOUNDARY SURVEY WAS NOT PERFORMED FOR THE PREPARATION OF THIS MAP.

COORDINATES ARE REFERENCED TO THE NEW YORK STATE PLANE COORDINATE SYSTEM WEST ZONE, NAD 83.

ELEVATIONS ARE REFERENCED TO THE NAVD 88 VERTICAL DATUM.

UNAUTHORIZED ALTERATION OR ADDITION TO ANY SURVEY, DRAWING, DESIGN, SPECIFICATION, PLAN OR REPORT IS A VIOLATION OF SECTION 7209, PROVISION 2 OF THE NEW YORK STATE EDUCATION LAW. ONLY COPIES FROM THE ORIGINAL OF THIS SURVEY MAP MARKED WITH AN ORIGINAL OF THE LAND SURVEYOR'S EMBOSSED SEAL AND SIGNATURE SHALL BE CONSIDERED TO BE VALID TRUE

- → PWRPOLEL

( CULV (LINE)

† CEMETERY

imes DTM SPOT

ANTENNA

SAT.DISH

— GUY (LINE)

#### EDGE OF PAVEMENT BUILDING UC GUARDRAIL TREELINE FOUNDATION \_\_ FENCE GATE MARSH OUTLINE RIVER HEDGE PAVED GUTTER DIRTROAD HEADWALL BUILDING (RES.) PIPE END RETAINING WALL <u>RECREATION</u> UNPAV INDEX OBS INDEX <u>INTER</u> <u>OBS</u> <u>INT</u>ER RECREATION PAVED INDEXD OBS INDEXD TRAIL INTERD OBS INDTERD BUILDING (MISC) SIDEWALK CREEK SOFTBREAK HARDBREAK GRID (w/text) OBSCURED AREA UNPAVED SHOULDER BUILDINGS (TEMP) SIGN/OH SIGN CANOPY ROAD PAINT FENCE GATE PKG PAINT PHONE TRAVELWAY PAVED DRIVE RAMP UNPAVED DRIVE SMOKE <u>CONTEXT</u>110— OH PIPE OH WALK BRIDGE CONVEYOR MAPPING LIMITS LANDFILL SLAB, CONCRETE OPEN STORAGE SYMBOLS □ CB OCB □ SQUARE CB -O- PWRPOLE ₩ FIREHYD ◇ DI

© DECIDUOUS BUSH

\* CONIFEROUS BUSH

DECIDUOUS TREE

\* CONIFEROUS TREE

MH

\* LAMPOST

⊳ SIGN

POST

HEAT PUMP / AC LANDSCAPE END EXP JOINT ROAD CENTERLINE UTILITY BOX GREENS \_\_\_\_ TRAPS\_BUNKERS TEES\_\_\_\_ <u>INDEFINITE AREA</u> CULTIVATED\_FIELD DOCK \_\_\_\_ BRIDGE\_ROAD BRIDGE CURB BRIDGE SIDEWALK MID EXP JOINT BRIDGE-BREAK OBSCURED BREAK ፟ዲ HANDI-CAP VALVE FLAG UNOB RAILSIG △ RAILSW □ TRABOX \* RUNLIGHT AC or HEAT PUMP \* TAXLIGHT → POLES (MISC) \* TRASIG TREEBOLE ■ MB

VERT

△ HOR

▲ HV

GOLF FAIRWAY

AIRFIELD PAVED

AIRFIELD SHLDR

HELICOPTER PAD

ABANDONED RR

PAVED PARKING

UNPAVED PARKING

AERIAL TC BOX

AIR VENT

PIPE


AIRFIELD PAINT

UNDER CONSTRUCTION



387 East Main Street Rochester NY 14604



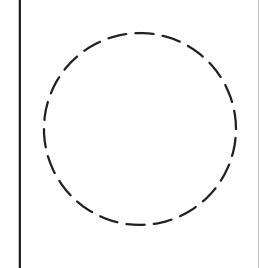

Drawn By: Checked By: Project Manager: M. POHL

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SWBR Project Number 18630.00

Community Foundation for **Greater Buffalo** 726 Exchange Street, Suite 525 Buffalo, NY 14210

L-000 Grabiarz

Existing Conditions/Survey

SITE DEMOLITION NOTES				
NO.	DESCRIPTION			
1	PROTECT PLAY EQUIPMENT IN PLACE. EXCAVATE AND DISPOSE OF EXISTING ENGINEERED WOOD FIBER TO DEPTH OF 1' AND ALL GEOTECH FABRIC.			
2	REMOVE AND SALVAGE EXISTING BENCH FOR REUSE ON SITE			
3	REMOVE AND DISPOSE OF EXISTING GOAL POST STRUCTURE INCLUDING CONCRETE FOOTERS (BOTH ENDS)			
4	REMOVE CHAIN LINK FENCE FABRIC. CONSTRUCT MOW STRIP PAVEMENT W/ POSTS IN PLACE. REINSTALL FENCE FABRIC.			
5	REMOVE AND DISPOSE OF TREE STUMP			
6	4 EVERGREENS (NOT SURVEYED) TO BE PROTECTED			
7	REMOVE AND DISPOSE OF FENCE, POSTS, AND FOOTERS			


#### GENERAL DEMOLITION NOTES

- 1. CONTRACTOR TO REMOVE & DISPOSE OF ALL ITEMS INDICATED & ANY ITEMS INCIDENTAL TO THE CONSTRUCTION AS REQUIRED.
- 2. CONTRACTOR TO PROTECT/PRESERVE ALL EXISTING ITEMS TO REMAIN, INCLUDING BUT NOT LIMITED TO BUILDINGS, PAVEMENT, OVERHEAD & BURIED UTILITIES, TREES, LANDSCAPE, ETC. DAMAGE TO ITEMS SCHEDULED TO REMAIN SHALL BE REPAIRED OR REPLANTED AT NO ADDITIONAL COST TO THE OWNER.
- 3. UTILITIES SHOWN ARE APPROXIMATE. CONTRACTOR SHALL HAVE ALL UNDERGROUND FACILITIES LOCATED AND MARKED PRIOR TO EXCAVATION/DEMOLITION CONSTRUCTION.
- 4. REMOVE CONCRETE SIDEWALK AND/OR PAVEMENT TO THE LIMITES INDICATED. SAW CUT CONCRETE TO THE NEAREST EXISTING CONTROL/EXPANSION JOINT.
- 5. CONTRACTOR SHALL MARK TREES (DESIGNATED FOR REMOVAL) IN THE FIELD AND OBTAIN OWNER'S ON-SITE REPRESENTATIVE APPROVAL PRIOR TO BEGINNING REMOVALS.
- 6. CLEAR AND GRUB ALL VOLUNTEER VEGETATION, AS INDICATED.
- 7. ALL EXISTING SITE FURNITURE TO BE REMOVED AND DISPOSED OF UNLESS OTHERWISE NOTED.


#### DEMOLITION LEGEND



BASE MATERIAL TO BE REMOVED AND DISPOSED OFF SITE.

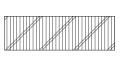

PROTECT EXISTING PLAYGROUND EQUIPMENT IN PLACE. EXCAVATE ALL MATERIAL IN SAFETY ZONE TO DEPTH OF 1' AND DISPOSE OFF SITE.

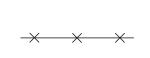

SITE ELEMENT TO BE REMOVED AND DISPOSED OFF SITE IN A LEGAL MATTER.


TREE TO REMAIN AND BE PROTECTED



SAW CUT LINE



TREE TO BE REMOVED

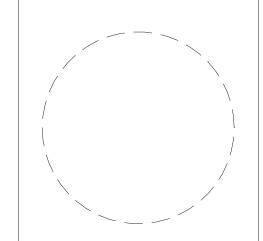

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Revisions

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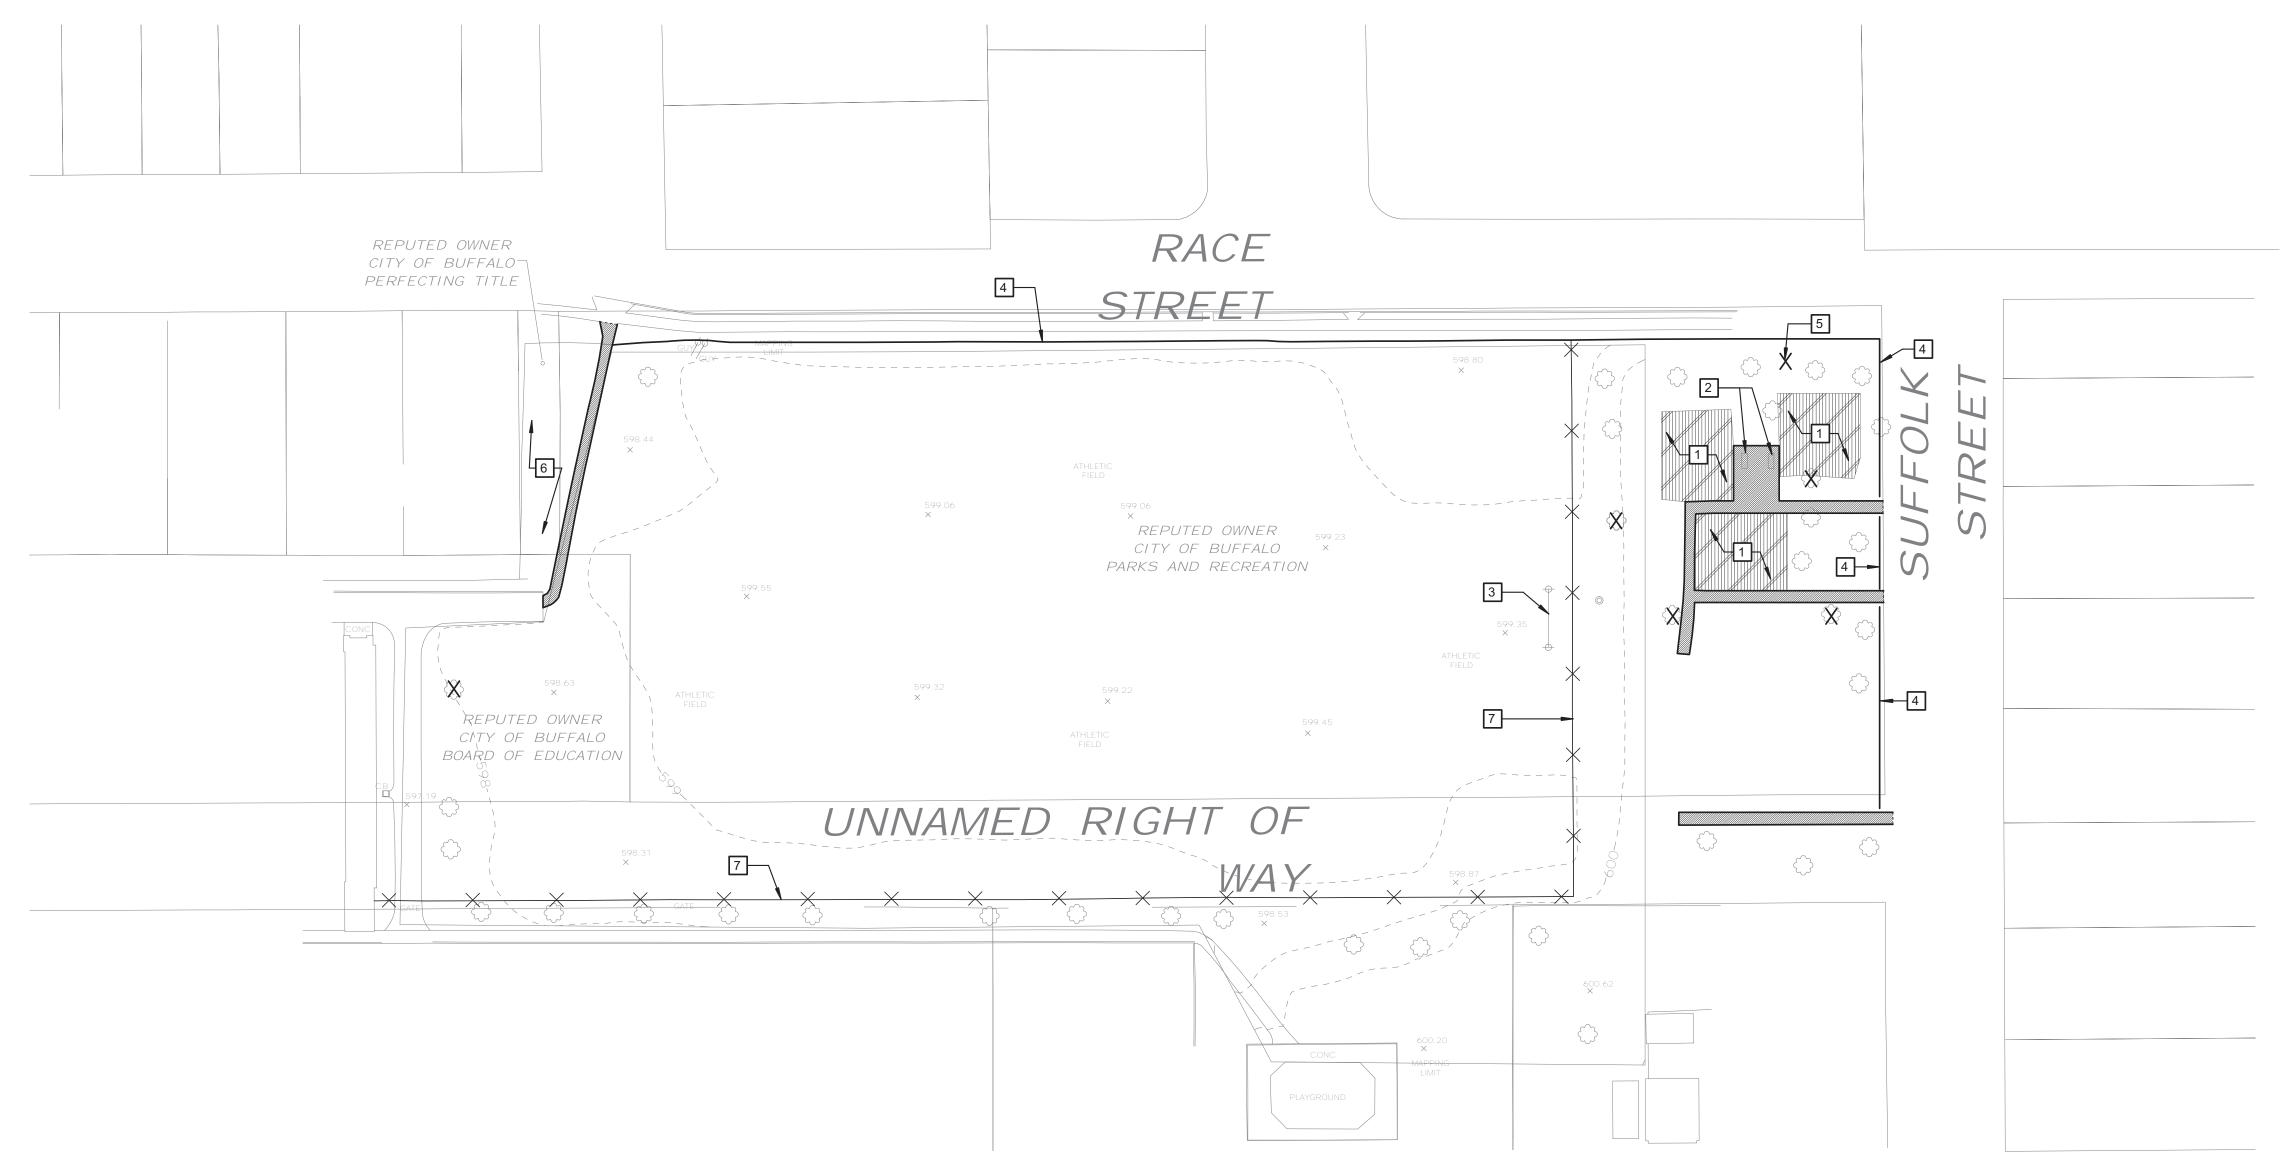
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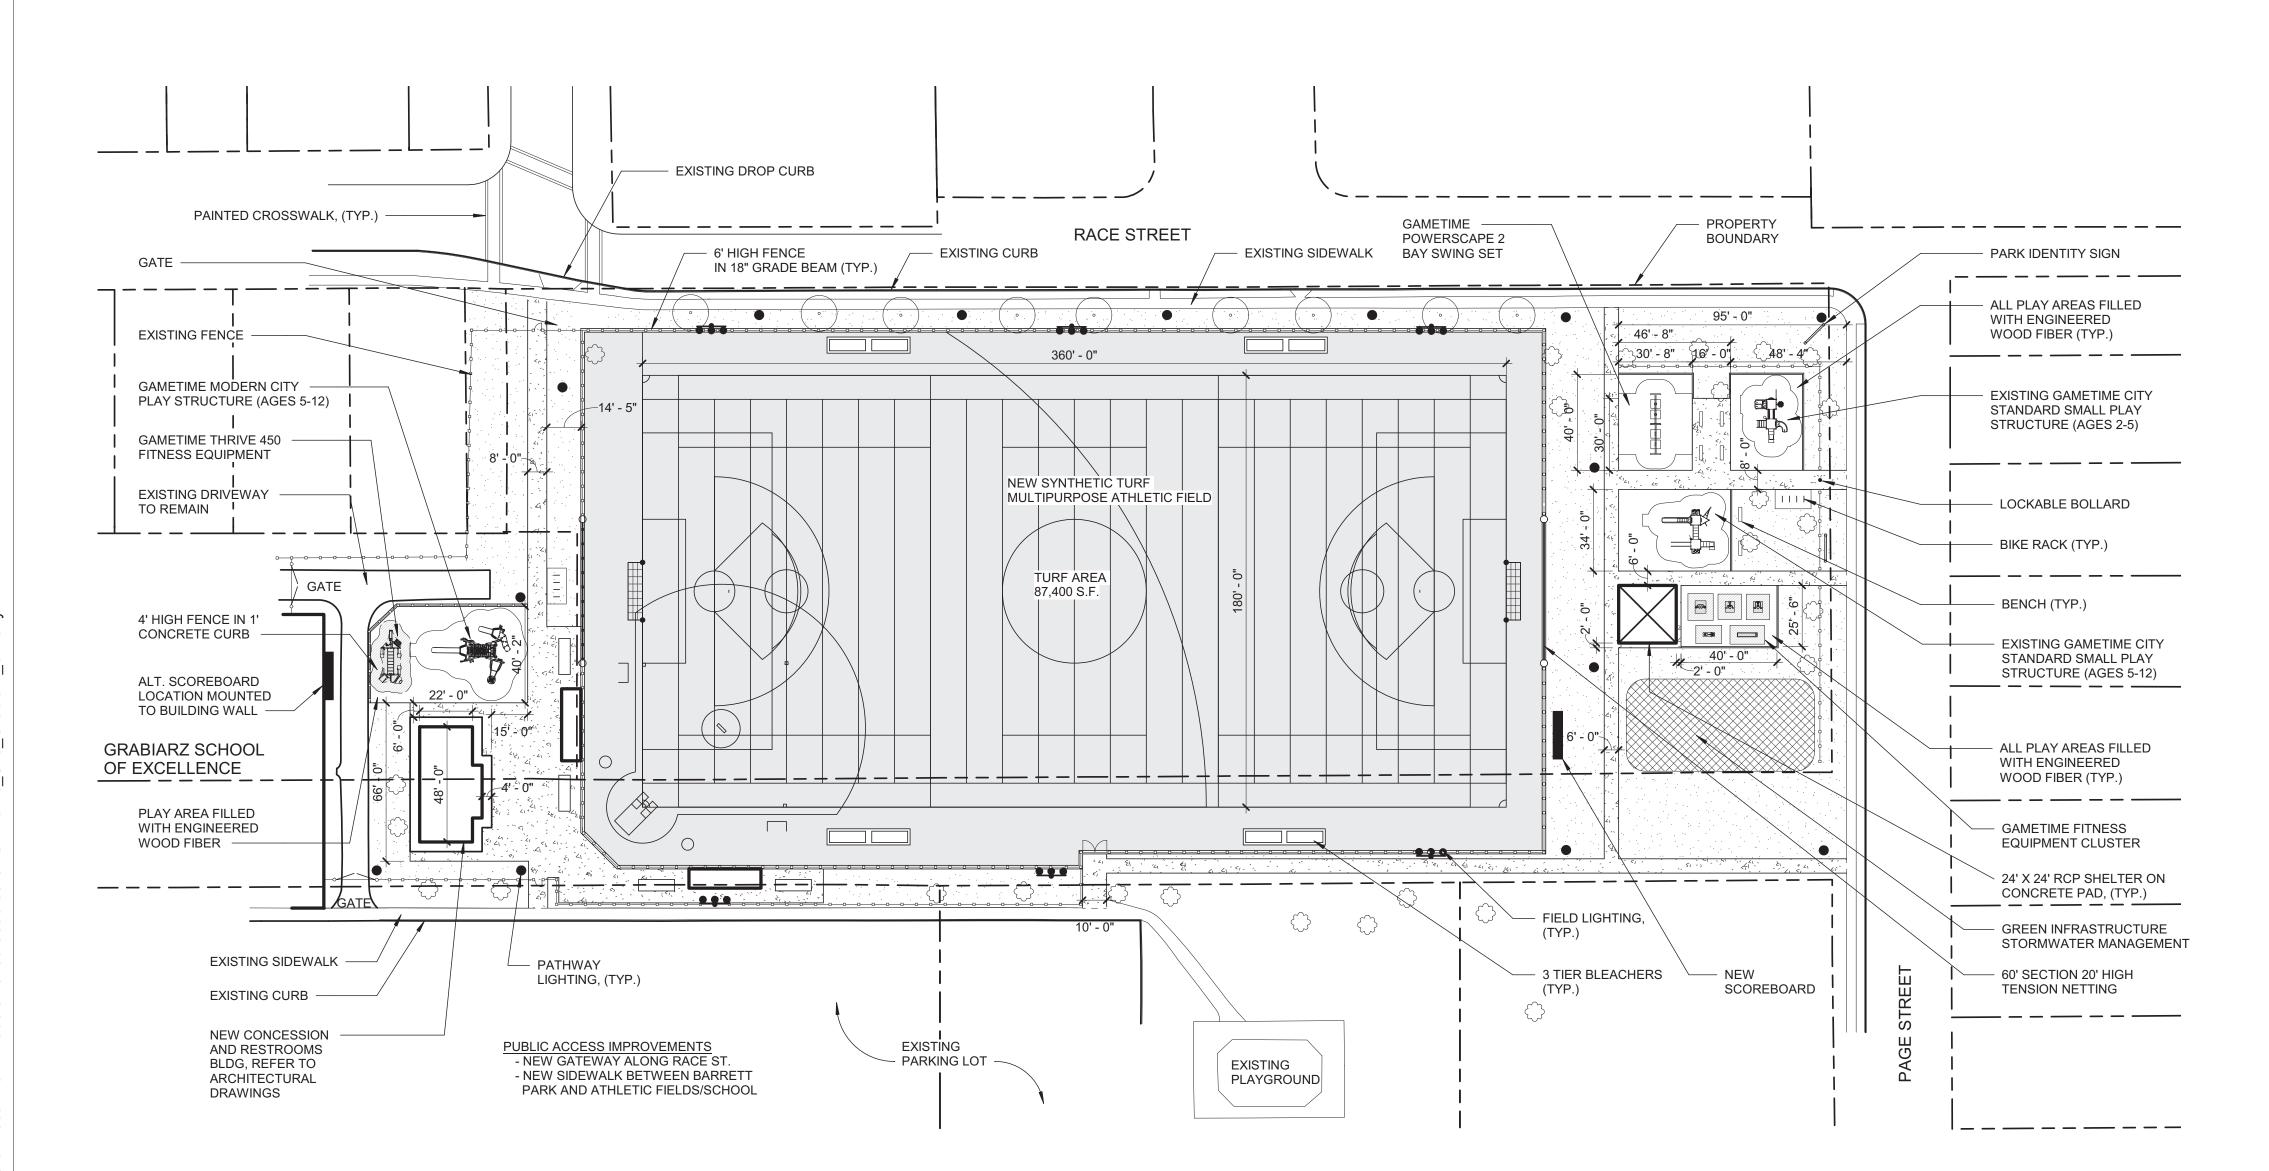
L-002

Grabiarz **Demolition Plan** 

03.29.2019 Design Development Set



GRABIARZ DEMOLITION PLAN



#### LANDSCAPE AND PAVING LEGEND

----- PROPERTY LINES

-4 ...4

CONCRETE



LAWN (TOPSOIL AND SEED)



STONE DUST WALKING SURFACE



SYNTHETIC TURF ATHLETIC FIELD



NEW SOD TO REESTABLISH FIELD EDGE (BASEBALL/SOFTBALL)



PROPOSED PLANT BED



ASPHALT WALKWAY



EXISTING TREE TO REMAIN



PROPOSED TREE














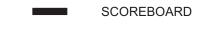










SYNTHETIC TURF FIELD

COMPLIES WITH NFHS FIELD SIZE STANDARDS FOR FOOTBALL, SOCCER AND LACROSSE



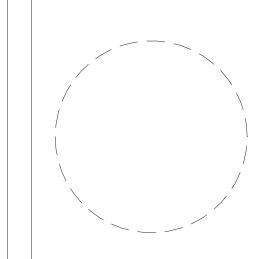

Drawn By: Author
Checked By: Checker
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L-101 Grabiarz

Site Layout Plan

GRADING, DRAINAGE & UTILITY PLAN

SCALE: 1" = 40'

#### GRADING & UTILITY NOTES

- STORM PIPING TO BE HDPE UNLESS OTHERWISE INDICATED. SANITARY SEWER PIPING TO BE SDR-35 PVC. WATER PIPING TO BE TYPE K COPPER OR DUCTILE IRON. PIPE SIZING TO BE DETERMINED DURING FINAL DESIGN.
- ALL UNDERDRAIN PIPING TO BE 4" DIAMETER PERFORATED HDPE OR PANEL UNDERDRAIN AS INDICATED ON PLANS. UNDERDRAIN AND PANEL DRAIN PIPE TO SLOPE TOWARD CONNECTIONS TO STORM SYSTEM.
- 3. THE PROJECT MAY BE SUBJECT TO THE REQUIREMENTS OF NYSDEC SPDES GENERAL PERMIT FOR STORMWATER DISCHARGES FROM CONSTRUCTION ACTIVITY, GP-0-15-002. A STORMWATER POLLUTION PREVENTION PLAN (SWPPP) IS REQUIRED FOR THE PROJECT AS WELL AS EROSION AND SEDIMENT CONTROL PLANS PREPARED IN ACCORDANCE WITH THE "NEW YORK STATE STANDARDS AND SPECIFICATIONS FOR EROSION AND SEDIMENT CONTROL."
- 4. UNDERGROUND DETENTION LOCATION AND SIZE IS SCHEMATIC ONLY. STORMWATER MANAGEMENT SYSTEM (WATER QUANTITY AND QUALITY MEASURES) TO BE DESIGNED TO MEET SWPPP REQUIREMENTS DURING FINAL DESIGN.

#### UTILITY KEY NOTES

- NEW WATER SERVICE LATERAL TO CONNECT TO EXISTING WATER MAIN
- NEW SANITARY SEWER LATERAL TO CONNECT TO EXISTING SEWER MAIN
- NEW ROOF DRAINAGE STORM LATERAL TO CONNECT FROM BUILDING TO EXISTING CATCH BASIN #1
- CONNECT NEW STORM TO EX. STORM OR SEWER, VERIFY EX. LOCATIONS AND ELEVATIONS IN THE FIELD
- NEW PERIMETER TRENCH DRAIN, CONNECT AND SLOPE
  TO NEW STORM SYSTEM
- 6 PERIMETER STORM DRAINAGE PIPING TO COLLECT UNDERDRAIN AND TRENCH DRAIN FLOW

### STORM DRAINAGE STRUCTURES


I.D. DESCRIPTION		RIM	INVERT
ST MH #1	STORM MANHOLE	601.3	593.0
ST MH #2	STORM TREATMENT MH	600.4	593.5
ST UG #1	STORMWATER DETENTION STRUCTURE	VARIES	593.0
CB #1	EX. CATCH BASIN	EXISTING	TBD


#### LEGEND

600	EX. CONTOUR
<del></del>	PROP. CONTOUR
667.0	PROP. SPOT ELEVATION
ST	STORM DRAINAGE PIPE
SAN	SANITARY SEWER PIPE
——— w———	WATER PIPE
	STORM UNDERDRAIN OR PANEL DRAIN
	STORM TRENCH DRAIN
$\mathfrak{S}$	STORM DRAINAGE MANHOLE
$\boxtimes$	CATCH BASIN
$\otimes$	YARD DRAIN
SA)	SANITARY SEWER MANHOLE
o co	CLEANOUT
	FIRE HYDRANT
$\bowtie$	WATER VALVE
0	YARD HYDRANT
СВ	CATCH BASIN
YD	YARD DRAIN
ST MH	STORM DRAINAGE MANHOLE
SS MH	SANITARY SEWER MANHOLE
TW / BW	TOP OF WALL / BOTTOM OF WALL
TS / BS	TOP OF STAIR / BOTTOM OF STAIR



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Checked By: DLP
Project Manager: DLP
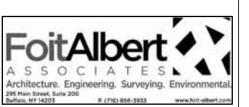
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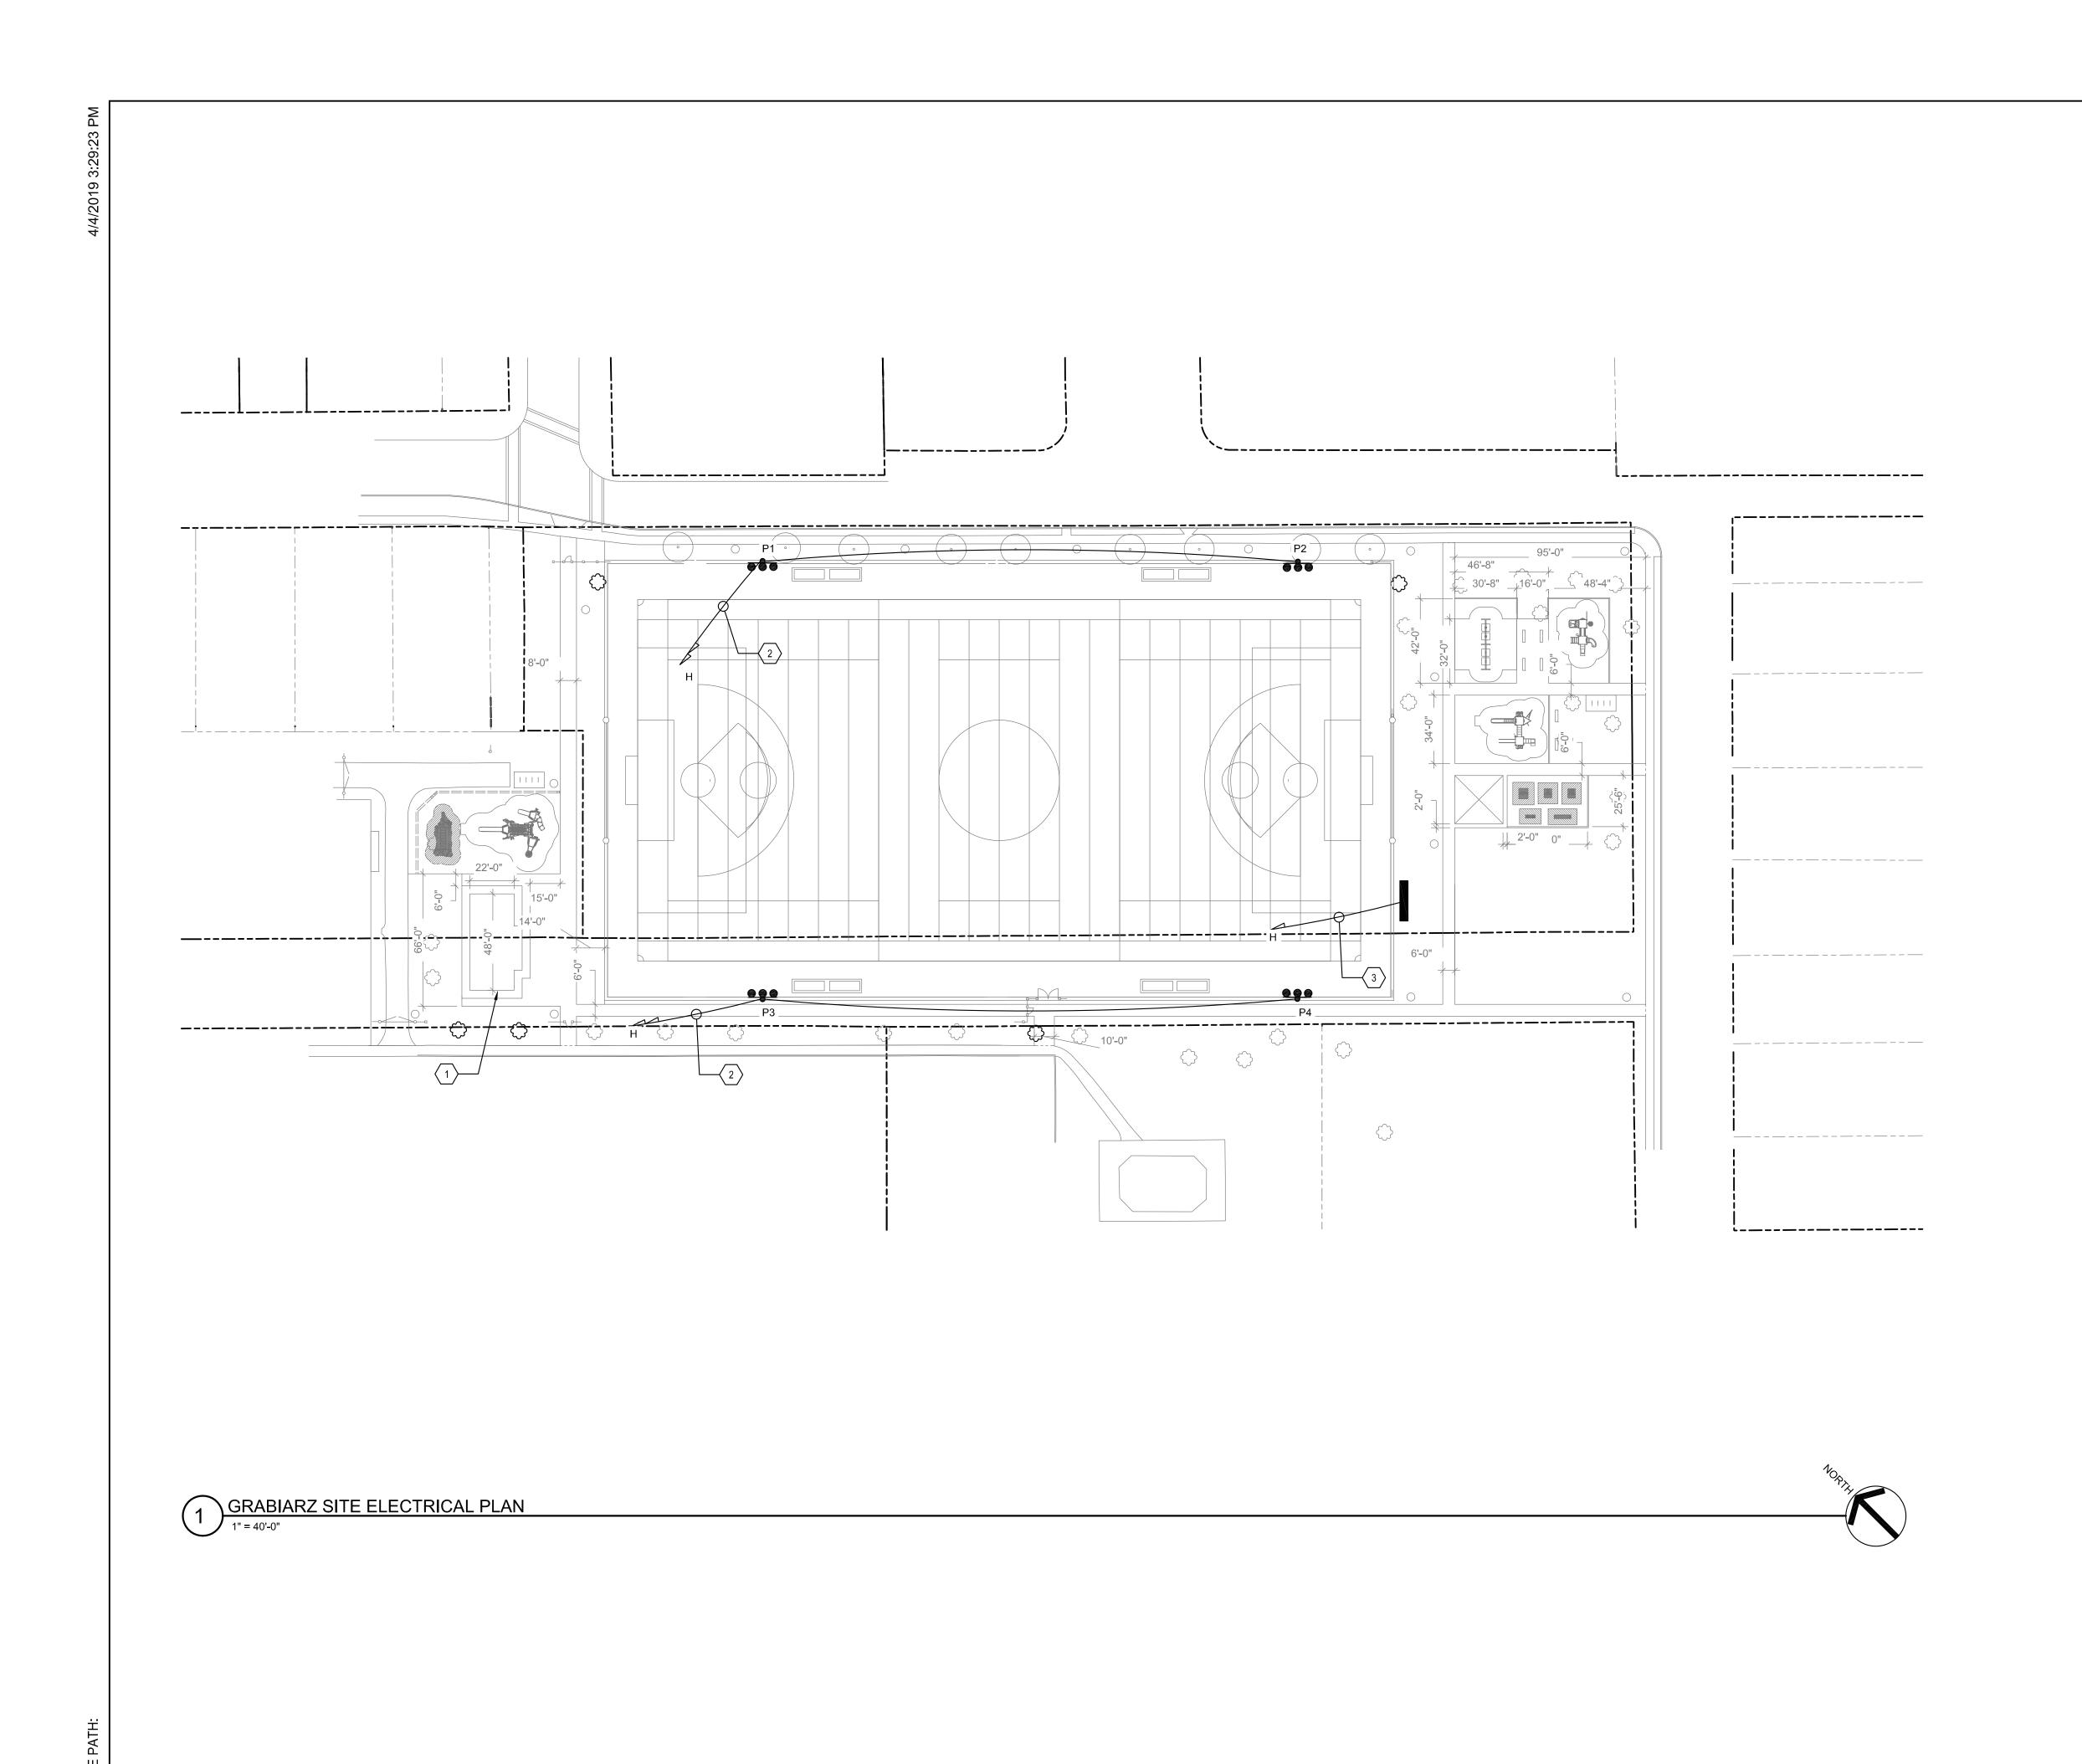
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C-101

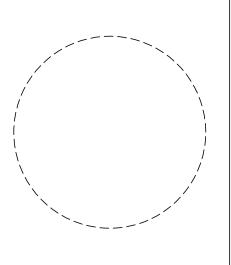**Grabiarz**Grading, Drainage &
Utility Plan



#### LEGEND:

FIELD LIGHTING

PATHWAY LIGHTING

LAMPPOLE TO REMAIN

SECURITY CAMERA

SCOREBOARD


BRANCH CIRCUIT TO PANELBOARD. LETTERING INDICATES PANELBOARD DESIGNATIONS. QUANTITY OF ARROWHEADS INDICATE QUANTITY OF BRANCH CIRCUITS.

#### KEYED DRAWING NOTES: (#)

- PROVIDE 208V, 3 PHASE, 200 AMP PANEL 'H' TO BE USED FOR NEW FIELD LIGHTING.
- 2. PROVIDE 208V, 3 PHASE, 40 AMP CIRCUIT CONSISTING OF (3)#6 AWG CONDUCTORS WITH (1) #10 EQUIPMENT GROUNDING CONDUCTOR IN 1" CONDUIT. EACH LAMP POLE SHALL BE PROVIDED (1) CIRCUIT.
- 3. PROVIDE 2 POLE, 60 AMP NEMA 3R DISCONNECT SWITCH AND A CIRCUIT CONSISTING OF (2) #4 AWG CONDUCTORS WITH (1) #10 EQUIPMENT GROUNDING CONDUCTOR IN 1" CONDUIT TO PANEL 'H'.
- 4. PROVIDE 2 POLE, 60 AMP NEMA 3R DISCONNECT SWITCH AND A CIRCUIT CONSISTING OF (2) #6 AWG CONDUCTORS WITH (1) #10 EQUIPMENT GROUNDING CONDUCTOR IN 1" CONDUIT TO EXISTING PANEL IN CONCESSION BUILDING.

POLE SUMMARY						
POLES	TOTAL WATTS	# LUMS	MH			
P1	5367	7	70			
P2	5367	7	70			
P3	5367	7	70			
P4	5367	7	70			
TOTAL	21468					



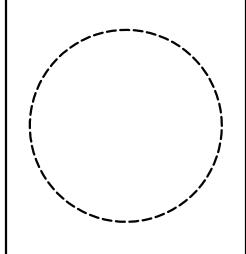

Drawn By:	MPC
Checked By:	MJS
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City of Buffalo Parks & Buffalo Public School Facilities Survey & Design Development SWBR Project Number 18630.00

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PLAN

Grabiarz ELECTRICAL SITE